CONSTRUCTION NOTES


- 1. ALL CONSTRUCTION AND MATERIALS SHALL CONFORM WITH THE CURRENT STANDARDS AND SPECIFICATIONS OF THE VIRGINIA DEPARTMENT OF HIGHWAYS AND TRANSPORTATION.
- 2. ALL STORM SEWER SHALL BE ASTM, C-76, CLASS III, EXCEPT AS NOTED. 3. ALL DRAINAGE STRUCTURES SHALL BE EITHER PRECAST OR CAST-IN-PLACE CONCRETE.
- 4. THE CONTRACTOR SHALL NOTIFY THE DEPARTMENT OF PUBLIC UTILITIES PRIOR TO MAKING ANY ADJUSTMENTS TO THE WATER OR SEWERAGE SYSTEMS.
- 5. THE CONTRACTOR SHALL NOTIFY RICHMOND PUBLIC WORKS AT LEAST 24 HOURS PRIOR TO STARTING WORK ON THE PROJECT.
- 6. A DI ON GRADE SHALL BE POURED WITH THE THROAT ON THE SAME GRADE
- AS THE ADJOINING CURB AND GUTTER. 7. THE PAVEMENT DESIGN IS SUBJECT TO CHANGE DUE TO SOIL CONDITION AT THE TIME OF CONSTRUCTION, AS DETERMINED ENGINEER.
- 8. ALL DIMENSIONS ARE TO FACE OF CURB OR BUILDING.
- 9. ANY DIMENSION THAT DOES NOT SCALE AS NOTED MUST BE CONFIRMED WITH THE DESIGN ENGINEER.
- 10. ALL CURB RADII ARE 5.0' UNLESS NOTED OTHERWISE. 11. TRAFFIC PAINT SHALL BE WHITE (ON ASPHALT) OR 'ADA' BLUE (ON HANDICAPPED SPACES). PARKING STRIPES SHALL BE 4" WIDE.

STOP BARS SHALL BE 24" WIDE AND BE PLACED 10' FROM RIGHT

- OF WAY. PER CURRENT VDOT STANDARDS. 12. STOP SIGNS AND HANDICAP PARKING SIGNS SHALL CONFORM TO THE "MANUAL OF UNIFORM TRAFFIC CODE DEVICES" AND THE VIRGINIA SUPPLEMENT
- 13. CONTRACTOR SHALL ACQUIRE ANY AND ALL NECESSARY CONSTRUCTION PERMITS.
- 14. ALL CONSTRUCTION MATERIALS AND WORKMANSHIP MUST CONFORM TO THE FOLLOWING STANDARDS AND SPECIFICATIONS:
 - VIRGINIA DEPARTMENT OF TRANSPORTATION
 - VIRGINIA DEPARTMENT OF HEALTH
 - RICHMOND DEPARTMENT OF UTILITIES RICHMOND DEPARTMENT OF COMMUNITY DEVELOPMENT

ALL CONSTRUCTION SHALL BE IN ACCORDANCE WITH V.D.O.T. STANDARDS.

- 15. ELECTRIC POWER, TELEPHONE POWER, AND GAS SUPPLY TRENCHES ARE TO BE COMPACTED, MULCHED AND SEEDED WITHIN 15 DAYS AFTER BACKFILL.
- 16. VIRGINIA LAW REQUIRES THE CONTRACTOR NOTIFY MISS UTILITY AT 1-800-552-7001 AT LEAST 48 HRS. PRIOR TO ANY LAND DISTURBANCE. THIS PLAN DOES NOT GUARANTEE THE EXISTENCE OF LOCATION OF UNDERGROUND UTILITIES. THE UNDERGROUND UTILITIES SHOWN HEREON WERE ESTABLISHED USING ABOVE GROUND STRUCTURES (VALVES, METERS, MANHOLES, ETC.) AND AVAILABLE UTILITY MAPS. PRIOR TO ANY EXCAVATION OR CONSTRUCTION, THE CONTRACTOR SHALL UNCOVER ALL UTILITIES WHICH ARE SHOWN ON THE PLANS OR WHICH HAVE BEEN MARKED BY MISS UTILITY AS BEING IN THE AREA OF EXCAVATION OR CONSTRUCTION. THE CONTRACTOR SHALL TAKE VERTICAL AND HORIZONTAL MEASUREMENTS ADEQUATE TO DETERMINE IF ANY CONFLICT WILL OCCUR. IF ANY POTENTIAL CONFLICT IS FOUND, THE CONTRACTOR SHALL NOTIFY THE SITE ENGINEER PRIOR TO BEGINNING ANY EXCAVATION OR CONSTRUCTION. THE CONTRACTOR SHALL BE RESPONSIBLE FOR REMOVING AND REINSTALLING AT HIS EXPENSE ANY UTILITY WHICH MUST BE RELOCATED BECAUSE OF A CONFLICT WHICH WAS NOT REPORTED TO THE SITE ENGINEER PRIOR TO THE BEGINNING OF ANY EXCAVATION OR CONSTRUCTION.
- 17. ALL WORK SHALL BE DONE IN ACCORDANCE WITH THE PLANS AND SPECIFICATIONS. ANY WORK OR MATERIAL NOT IN CONFORMANCE WITH THESE DOCUMENTS IS SUBJECT TO REMOVAL AND REPLACEMENT AT THE CONTRACTOR'S EXPENSE.
- 18. ANY QUANTITIES PROVIDED ON THE PLANS ARE APPROXIMATE. THE CONTRACTOR IS RESPONSIBLE FOR VERIFYING THE QUANTITIES AND SUBMITTING HIS BID ACCORDINGLY.
- 19. ALL EXISITNG UTILITIES, SERVICE POLES, AND CONNECTIONS SHALL BE PROTECTED AT THE CONTRACTOR'S EXPENSE. IF DAMAGE IS CAUSED BY CONSTRUCTION TO ANY EXISTING UTILITY, THE CONTRACTOR SHALL BE RESPONSIBLE FOR THE REPAIR OR RESTORATION OF SAME.
- 20. CONTRACTOR SHALL PRESERVE ALL CONERSTONES, IRON PINS, CONCRETE MONUMENTS, OR ANY OTHER TYPE OF MONUMENTATION. THE CONTRACTOR SHALL ALSO PROVIDE A REGISTERED SURVEYOR TO RESTORE ANY/ALL MONUMENTATION SHOULD THAT MONUMENTATION BECOME DAMAGED OR DESTROYED.
- 21. ROOF DRAINS, FOUNDATION DRAINS, AND OTHER CLEAN WATER CONNECTIONS TO THE SANITARY SEWER SYSTEM ARE PROHIBITED, EXCEPT IN THE INSTANCE OF EXISTING COMBINED SEWER.
- 22. ALL EQUIPMENT AND MATERIALS DESIGNATED FOR REMOVAL SHALL BECOME THE PROPERTY OF THE CONTRATOR UNLESS NOTED ON PLANS.

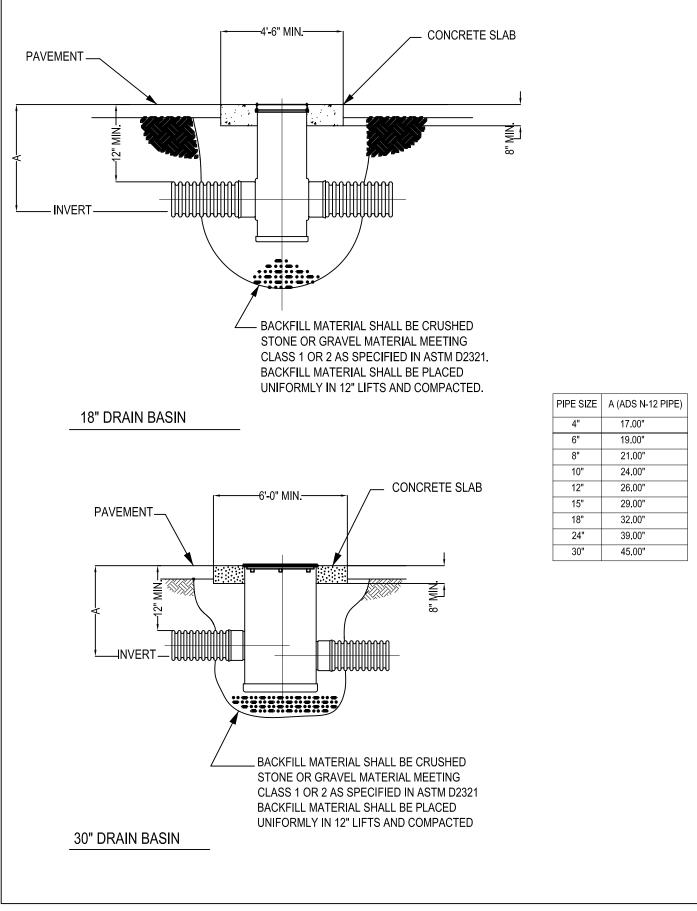


DRAIN BASIN INSTALLATION DETAIL

UTILITY NOTES


- 1. THE CONTRACTOR SHALL NOTIFY THE APPROPRIATE CITY DEPARTMENT PRIOR TO MAKING ANY UTILITY ADJUSTMENTS OR PERFORMING OTHER WORK WITHIN THE RIGHT-OF-WAY.
- 2. THE SEQUENCE OF UTILITY CONSTRUCTION SHALL BE DEVELOPED IN SUCH A MANNER THAT WATER AND SANITARY SEWER SERVICE IS MAINTAINED AT ALL TIMES DURING CONSTRUCTION EXCEPT DURING TIE-INS AND CONNECTIONS. WHEN SERVICE IS INTERRUPTED, THE CONTRACTOR SHALL PROVIDE THE CITY WITH 72 HOURS NOTICE PRIOR TO THE INTERRUPTION. THE AFFECTED PROPERTY OWNER SHALL BE NOTIFIED WITHIN 48 HOURS PRIOR TO SERVICE INTERRUPTIONS. CONTRACTORS SHALL PROVIDE THE CITY WITH A DETAILED PLAN AND SCHEDULE FIVE (5) WORKING DAYS IN ADVANCE TO PERFORMING WORK WHICH REQUIRES INTERRUPTION TO CUSTOMER UTILITY SERVICE SERIVCE INTERRUPTIONS SHALL BE KEPT TO A MINIMUM.
- 3. UNLESS OTHERWISE NOTED, ALL GAS AND WATER UTILITY MATERIALS AND CONSTRUCTION METHODS SHALL BE IN ACCORDANCE WITH THE STANDARD SPECIFICATION FOR GAS AND WATER SYSTEM-CONSTRUCTION AND MAINTENANCE DPU NO. 1-92, LATEST EDITION. THE CITY OF RICHMOND'S SEWER SPECIFICATIONS AND THE LATEST EDITIONS OF THE VIRGINIA DEPARTMENT OF HEALTH WATERWORKS REGULATIONS AND PROPOSED SEWAGE COLLECTION AND TREATMENT REGULATIONS.
- 4. LOCATIONS OF EXISTING UTILITIES ACROSS OR ALONG THE LINE OF THE PROPOSED WORK ARE SHOWN ONLY IN AN APPROXIMATE LOCATION ON THE PLANS. CONTRACTOR SHALL LOCATE ALL UNDERGROUND LINES AND STRUCTURES AS NECESSARY. CONTRACTOR SHALL CALL "MISS UTILITY 1-800-552-7001 PRIOR TO CONSTRUCTION AND IS RESPONSIBLE FOR ANY DAMAGE TO UNDERGROUND LINES OR STRUCTURES.
- 5. GATE VALVES SHALL BE U.S. PIPE, METROSEAL 250, OPEN RIGHT (CLOCKWISE), WITH MECHANICAL JOINT END FITTINGS, NON-RISING STEM.
- 6. FIRE HYDRANTS SHALL BE U.S. PIPE, METROPOLITAN 250, OPEN RIGHT (CLOCKWISE), WITH A 4 1/2 " VALVE OPENING.
- 7. ALL FIRE HYDRANTS AND VALVE BOXES DESIGNATED TO BE REMOVED SHALL BE SALVAGED AND

DELIVERED TO THE DEPARTMENT OF UTILITIES AT 400 JEFFERSON DAVIS HIGHWAY.


- 8. ALL GAS AND WATER SERVICES AND SEWER CONNECTIONS SHALL BE RENEWED AS DIRECTED BY THE CITY OF RICHMOND, DEPARTMENT OF PUBLIC UTILITIES ENGINEER
- 9. THE CONTRACTOR IS RESPONSIBLE FOR OBTAINING ALL PERMITS
- 10. DATUM FOR ALL ELEVATIONS SHOWN IS NATIONAL GEODETIC SURVEY.
- 11. MINIMUM DEPTH OF COVER FOR GAS AND WATER MAINS IS 42 INCHES.
- 12. WATER MAINS SHALL BE DUCTILE IRON, DOUBLE COAT CEMENT LINED AS MANUFACTURED BY U.S. PIPE OR EQUAL. PIPE CLASS SHALL BE AS FOLLOWS: DIAMETER (INCHES) SPECIAL CLASS

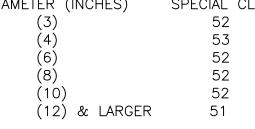

- 13. THE CITY WILL INSPECT ALL GAS, WATER AND SANITARY SEWER MAINS, CONNECTIONS AND APPURTENANCES TO INSURE THAT THE MATERIALS AND CONSTRUCTION METHODS ARE IN ACCORDANCE WITH THE APPROVED PLANS, SPECIFICATION AND STANDARDS. ALL OTHER LINES AND CONNECTIONS WILL BE INSPECTED AND APPROVED BY THE DEPARTMENT OF BUILDING INSPECTIONS.
- 14. THE CONTRACTOR SHALL REQUEST VALVE OPERATION BY THE OWNER'S FORCES NO LESS THAN 48 HOURS IN ADVANCE. THE CONTRACTOR SHALL NOT OPERATE ANY EXISTING VALVES UNLESS DIRECTED BY THE OWNER.
- 15. THE CITY DOES NOT GUARANTEE A 100 PERCENT SHUTDOWN OF ITS EXISTING WATER MAINS. THE CONTRACTOR SHALL PROVIDE ALL PLUGS AND DE WATERING EQUIPMENT NECESSARY TO PERFORM THE WORK.
- 16. MECHANICAL JOINT LONG SOLID SLEEVES SHALL BE USED FOR ALL CONNECTION TO EXISTING WATER MAINS.
- 17. COUPLINGS FOR CONNECTIONS TO EXISTING SANITARY SEWER LATERALS SHALL BE FERNCO OR
- 18. BASED ON CITY RECORDS, EXISTING SANITARY SEWER LATERALS ARE ASSUMED TO BE 6-INCHES WITHIN THE RIGHT-OF-WAY AND 18. 4-INCHES ON PRIVATE PROPERTY.

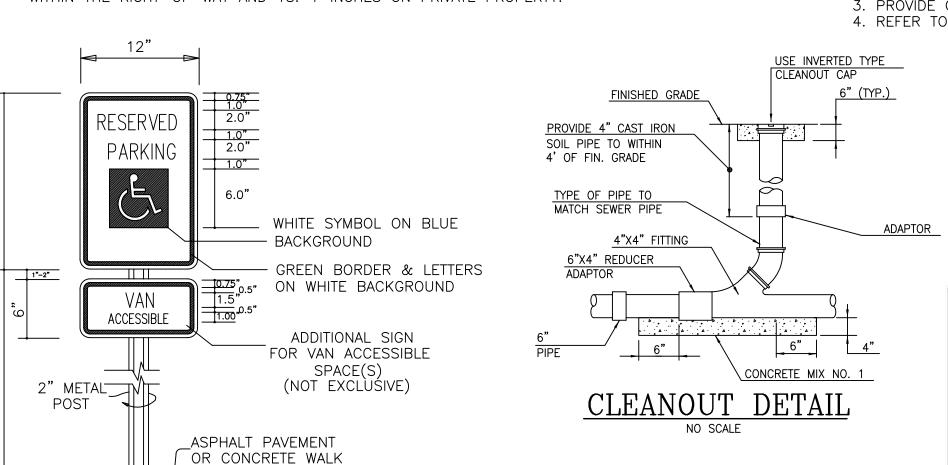

HANDICAP PARKING SIGN DETAIL

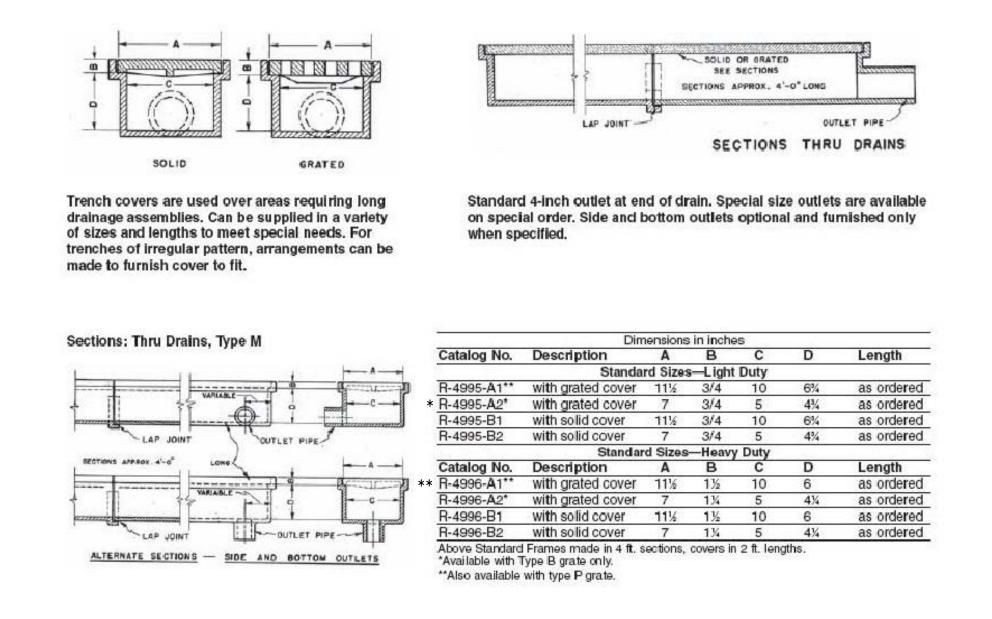

** HEAVY DUTY TRENCH DRAIN FOR END OF LOADING DOCK RAMP


BASED ON TRENCH DRAIN TRENCH DRAIN DETAIL DETAIL FROM NEENAH FOUNDARY * LIGHT DUTY TRENCH DRAIN FOR BACK SERVICE AREA


GENERAL WATER NOTES

- 1. ALL MATERIALS FOR WATER SHOWN SHALL BE SUPPLIED AND INSTALLED IN ACCORDANCE WITH THE LATEST APPLICABLE CODES AND SPECIFICATIONS OF THE CITY OF RICHMOND. DEPARTMENT OF PUBLIC UTILITIES REQUIREMENTS ARE: STANDARD SPECIFICATIONS FOR GAS AND WATER AND WATER SYSTEM CONSTRUCTION & MAINTENANCE (DPU NO. 192 OR LATEST EDITION).
- RULES AND REGULATIONS FOR THE MUNICIPAL WATER SUPPLY OF RICHMOND, VIRGINIA, LATEST CITY OF RICHMOND SPECIFICATIONS FOR DUCTILE IRON WATER PIPE AND FITTINGS, LATEST EDITION. CITY OF RICHMOND STANDARD DETAIL DRAWINGS FOR METERS AND FIRELINES.
- 2. ALL WORK SHALL BE SUBJECT TO INSPECTION BY UTILITY DEPARTMENT OFFICIALS. THE CONTRACTOR SHALL BE RESPONSIBLE FOR NOTIFICATION OF APPROPRIATE CITY OFFICIALS 48 HOURS PRIOR TO START OF WORK.
- 3. THE UTILITY CONTRACTOR IS RESPONSIBLE FOR OBTAINING ANY HIGHWAY PERMITS AND SENDING A COPY OF THE PERMIT TO THE CITY PRIOR STARTING ANY CONSTRUCTION WORK.
- 4. MINIMUM CLEAR COVER FOR ALL WATER PIPE, FIRE SERVICE LATERALS AND SERVICES SHALL BE 3.5 FEET, INCLUDING DITCH CROSSINGS.
- 5. ALL WATER SERVICES ARE TO BE COPPER, TYPE K DRAWN TUBING. SERVICE 3/4" TO 1" SHALL BE TYPE K SOFT COPPER AND SERVICE 1-1/2" TO 2" SHALL BE TYPE K HARD COPPER.
- 6. ON WATER MAINS INSTALLED BY THE CONTRACTOR, THE CONTRACTOR SHALL INSTALL ALL WATER SERVICE CONNECTIONS, EXCEPT FIRELINE SERVICES AND METER BOXES.
- 7. BACKFILL FOR ALL UTILITIES WITHIN CITY STREETS SHALL BE PLACED GENERALLY IN ACCORDANCE WITH CITY SPECIFICATIONS, AND THE FOLLOWING CRITERIA: (A) NO TRENCH SHALL BE BACKFILLED UNTIL AUTHORIZED BY THE CITY. MATERIAL USED FOR BACKFILL FROM THE BOTTOM OF THE TRENCH TO 12" (TWELVE INCHES) ABOVE THE PIPE SHALL BE SELECT MATERIAL, FREE FROM FROST, LARGE CLODS, STONES AND DEBRIS, AND
 - SHALL BE THOROUGHLY AND CAREFULLY COMPACTED. (B) BACKFILL SHALL BE COMPACTED BY MECHANICAL TAMPERING THROUGHOUT THE DEPTH OF THE TRENCH TO INSURE A SUITABLE SUBBASE, ACCEPTABLE TO THE ROAD ENGINEER, IF THE MATERIAL TAKEN FROM THE TRENCH IS NOT A SUITABLE SUBBASE, IT SHALL BE REMOVED AND ACCEPTABLE MATERIAL USED FOR BACKFILLING THE TRENCH.
- 8. THE ENGINEER WILL CERTIFY THAT THE ROADS AND DITCHES ARE WITHIN 6" OF SUBGRADE BEFORE WATERLINE CONSTRUCTION CAN BEGIN.
- 9. FOR WATER INSTALLATION WITHIN EXISTING RIGHT-OF-WAY, THE UTILITY CONTRACTOR MUST NOTIFY THE CITY INSPECTOR WHEN INSTALLATION BEGINS SO THAT DENSITY CAN BE TESTED (95% @ OPTIMUM MOISTURE +20%).
- 10. THE CONTRACTOR SHALL VERIFY LOCATION AND ELEVATION OF ALL UNDERGROUND UTILITIES IN AREAS OF CONSTRUCTION PRIOR TO STARTING WORK. CONTACT ENGINEER IMMEDIATELY IF LOCATION OR ELEVATION IS DIFFERENT FROM THAT SHOWN ON THE PLAN, OR IF THERE APPEARS TO BE A CONFLICT OR IF ANY UTILITY NOT SHOWN ON THE PLAN IS DISCOVERED. TO LOCATE UTILITIES, CALL "MISS UTILITY" OF CENTRAL VIRGINIA: 1-800-552-7001 (TOLL FREE).
- 11. ALL PLUMBING DIAGRAMS SHALL BE REVIEWED BY THE CROSS-CONNECTION SPECIALIST FOR CROSS-CONNECTION CONTROL AND BACKFLOW PREVENTION PRIOR TO ANY WATER PERMIT REQUEST. THE INSTALLATION OF BACKFLOW DEVICES IS REQUIRED IN ALL BUILDINGS WHERE THE FINISHED GRADE IS BELOW THE TOP ELEVATION OF NEAREST MANHOLE. THIS DEVICE WILL BE INSPECTED BY THE CITY PLUMBING INSPECTOR AT TELEPHONE NUMBER 646-6981 AND THE CROSS-CONNECTION SPECIALIST AT TELEPHONE NUMBER 646-8534.
- 12. ALL FUTURE BUILDINGS BELOW THE CONTOUR WILL REQUIRE INDIVIDUAL PRESSURE REGULATORS. 13. ALL UTILITIES SHALL BE IN PLACE PRIOR TO PLACEMENT OF BASE MATERIAL
- 14. THE CONTRACTOR SHALL OPEN AND PREPARE ALL TRENCHES FOR THE CITY TO MAKE ANY CONNECTIONS TO THE EXISTING WATER MAIN FOR THE PROJECT WATER MAINS OR SERVICES TO

STORM DRAIN PIPING NOTES

- I. PROVIDE PVC WATER TIGHT STORM SEWER PIPING IN ACCORDANCE WITH ASTM D 3034.
- . PROVIDE PVC FITTINGS IN ACCORDANCE WITH ASTM D 2464. 5. PROVIDE GASKETS WITH ELASTOMERIC SEALS MEETING ASTM 477.
- 4. REFER TO THE SPECIFICATIONS MANUAL FOR ADDITIONAL INFORMATION.

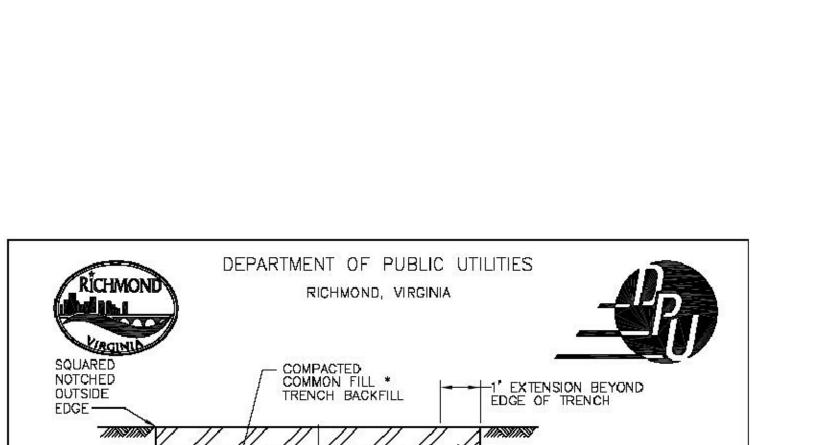

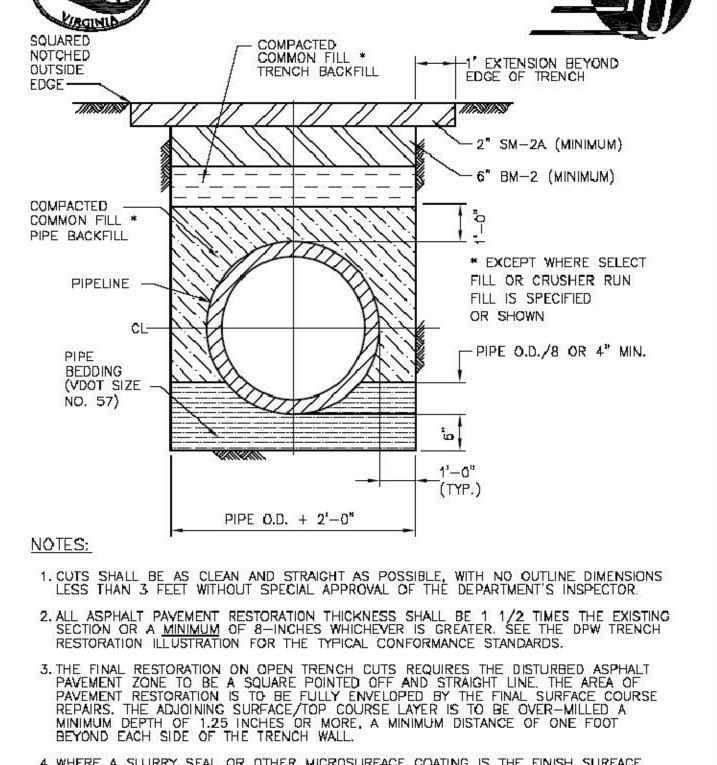

4. WHERE A SLURRY SEAL OR OTHER MICROSURFACE COATING IS THE FINISH SURFACE COURSE, A RE-TREATMENT APPLICATION IS REQUIRED.

DRAWN X

CHK,D X

DATE 6/28/04

SCALE NOT TO SCALE

CITY OF RICHMOND PIPE TRENCH DETAIL


CITY OF RICHMOND, VIRGINIA

PAVEMENT RESTORATION


FOR PIPE TRENCHES

DPU DWG. NUMBER:


M-3B

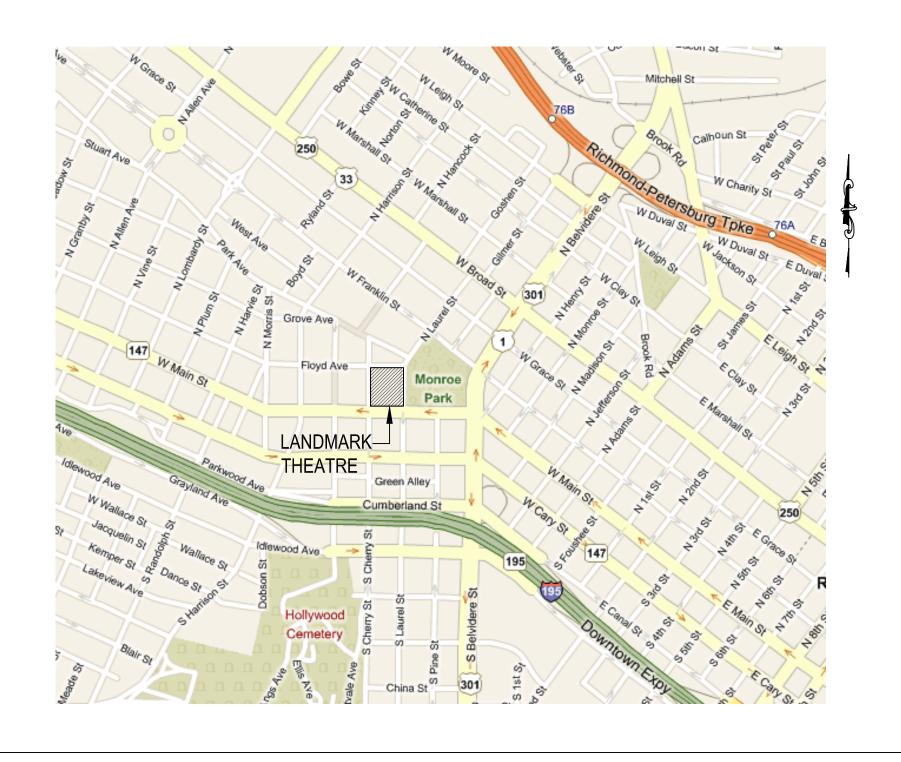

VICINITY MAP SCALE: 1"=2000' (<u>+</u>)

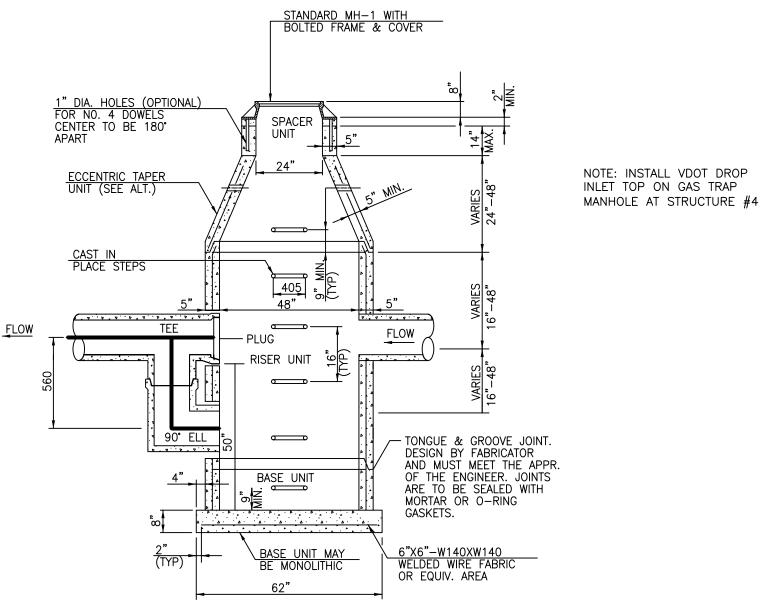

TYPICAL GAS TRAP MANHOLE DETAIL

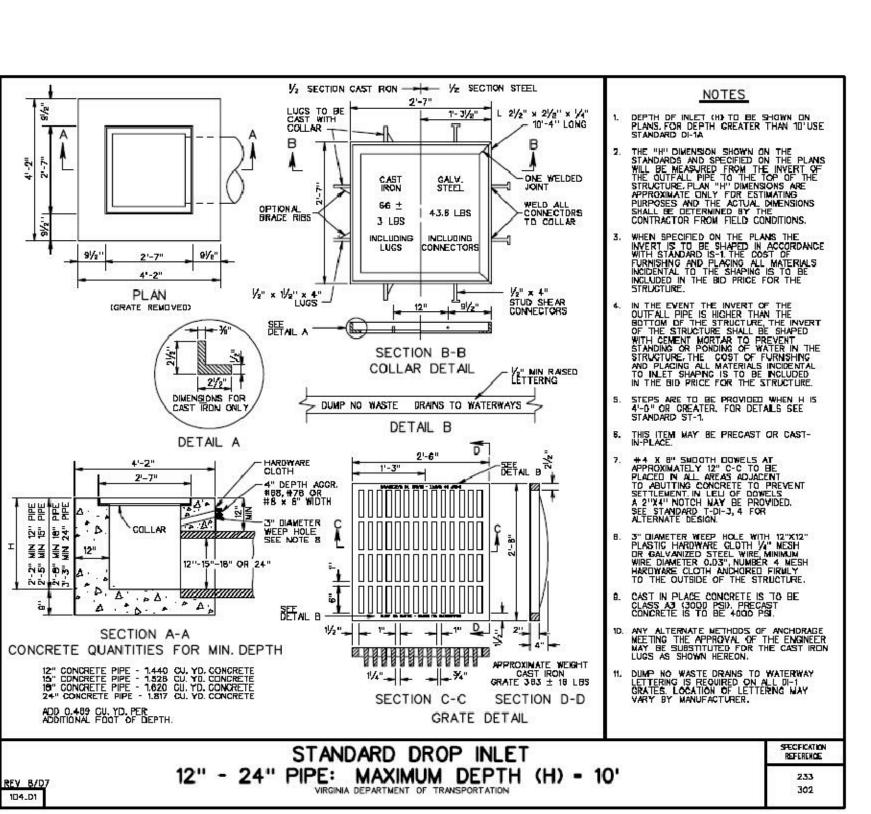

VDOT STD. DROP INLET DETAIL

NO SCALE





DRAWING TITLE: **NOTES & DETAILS**

34157

10.27.08

DRAWING NO.:

GENERAL EROSION AND SEDIMENT CONTROL NOTES

- (FROM CHAPTER 6 OF THE <u>VIRGINIA EROSION AND SEDIMENT CONTROL HANDBOOK</u>)
- ES-1: UNLESS OTHERWISE INDICATED, ALL VEGETATIVE AND STRUCTURAL EROSION AND SEDIMENT CONTROL PRACTICES WILL BE CONSTRUCTED AND MAINTAINED ACCORDING TO MINIMUM STANDARDS AND SPECIFICATIONS OF THE VIRGINIA EROSION AND SEDIMENT CONTROL HANDBOOK AND VIRGINIA REGULATIONS VR 625-02-00 EROSION AND SEDIMENT CONTROL REGULATIONS.
- ES-2: THE PLAN APPROVING AUTHORITY MUST BE NOTIFIED ONE WEEK PRIOR TO THE PRE-CONSTRUCTION CONFERENCE, ONE WEEK PRIOR TO THE COMMENCEMENT OF LAND DISTURBING ACTIVITY AND ONE WEEK PRIOR TO FINAL INSPECTION.
- ES-3: ALL EROSION AND SEDIMENT CONTROL MEASURES ARE TO BE PLACED PRIOR TO OR AS THE FIRST STEP IN CLEARING.
- ES-4: A COPY OF THE APPROVED EROSION AND SEDIMENT CONTROL PLAN SHALL BE MAINTAINED ON THE SITE AT ALL TIMES.
- ES-5: PRIOR TO COMMENCING LAND DISTURBING ACTIVITIES IN AREAS OTHER THAN INDICATED ON THESE PLANS (INCLUDING, BUT NOT LIMITED TO, OFF-SITE BORROW OR WASTE AREAS), THE CONTRACTOR SHALL SUBMIT A SUPPLEMENTARY EROSION CONTROL PLAN TO THE OWNER FOR REVIEW AND APPROVAL BY THE PLAN APPROVING AUTHORITY.
- ES-6: THE CONTRACTOR IS RESPONSIBLE FOR INSTALLATION OF ANY ADDITIONAL EROSION CONTROL MEASURES NECESSARY TO PREVENT EROSION AND SEDIMENTATION AS DETERMINED BY THE PLAN APPROVING AUTHORITY.
- ES-7: ALL DISTURBED AREAS ARE TO DRAIN TO APPROVED SEDIMENT CONTROL MEASURES AT ALL TIME DURING LAND DISTURBING ACTIVITIES AND DURING SITE
- DEVELOPMENT UNTIL FINAL STABILIZATION IS ACHIEVED. ES-8: DURING DEWATERING OPERATIONS, WATER WILL BE PUMPED INTO AN APPROVED
- ES-9: THE CONTRACTOR SHALL INSPECT ALL EROSION CONTROL MEASURES PERIODICALLY AND AFTER EACH RUNOFF-PRODUCING RAINFALL EVENT. ANY NECESSARY REPAIRS OR CLEANUP TO MAINTAIN THE EFFECTIVENESS OF THE EROSION CONTROL DEVICES SHALL BE MADE IMMEDIATELY.

EROSION AND SEDIMENT CONTROL NARRATIVE

A. PROJECT DESCRIPTION:

B. EXISTING SITE CONDITIONS:

FILTERING DEVICE.

THIS PROJECT REQUIRES MINOR SITE DEMOLITION. GRADING AND PAVING APPROPRIATE FOR CONSTRUCTION OF A PARKING LOT ADJACENT TO A BUILDING ADDITION AT THE LANDMARK THEATER. THE DISTURBED AREA OF THE SITE WILL BE APPROXIMATELY 0.40 ACRES.

THE EXISTING SITE IN THE AREA OF THE PROPOSED PARKING LOT

ADDITION IS UTILIZED AS A GRAVEL PARKING AND SERVICE AREA. DRAINAGE ACROSS THE PROJECT AREA FLOWS GENERALLY TO THE

THE PROJECT AREA IS WITHIN THE WALLED AREA OF THE

LANDMARK THEATER. D. OFF-SITE AREAS:

THIS PROJECT WILL NOT ADVERSELY IMPACT OFF SITE AREAS. IF OFF-SITE BORROW MATERIAL IS REQUIRED TO COMPLETE THE WORK, CONTRACTOR IS RESPONSIBLE FOR ENSURING PROPER EROSION CONTROL MEASTURES ARE IN PLACE, FUNCTIONAL AND MAINTAINED AT BORROW SITE LOCATION.

ACCORDING TO USDA SOIL SURVEY LAND IN THE AREA OF THE PROPOSED CONSTRUCTION IS 41 - URBAN LAND. REFER TO GEOTECHNICAL ENGINEERING STUDY BY SCHNABEI ENGINEERING, LLC DATED MAY 7, 2008 FOR SOIL INFORMATION

F. CRITICAL AREAS: THERE ARE NO CRITICAL EROSION AREAS WITHIN THE

PROJECT AREA.

G. EROSION & SEDIMENT CONTROL MEASURES NOTE: THE PROPOSED CONSTRUCTION WILL OCCUR ON EXISTING PAVED OR

GRAVEL AREAS THAT WILL NOT CAUSE EROSION. CONSTRUCTION ENTRANCE: THE EXISTING CONCRETE AND GRAVEL ENTRANCE FROM MAIN STREET WILL SERVE AS THE CONSTRUCTION ENTRANCE.

STORM DRAIN INLET PROTECTION — 3.07: STONE FILTERS SHALL BE PLACED AT THE INLET OF EXISTING DRAINAGE STRUCTURES AS INDICATED. H. PERMANENT STABILIZATION:

THE ENTIRE AREA SHALL BE PAVED OR BUILT UPON AT THE CONCLUSION OF THE PROJECT.

I. STORMWATER RUN-OFF CONSIDERATIONS: STORMWATER WILL BE COLLECTED ON-SITE AND DISCHARGED TO THE EXISTING CITY STORM SEWER SYSTEM. CURRENTLY, THE

EXISTING SITE RUNOFF SHEET FLOWS TO THE EXISTING SYSTEM.

ANALYSIS OF PRE AND POST DEVELOPMENT WILL BE TAKEN AT EXISTING INLET AT THE CORNER OF N. CHERRY STREET AND W. MAIN STREET. **STORMWATER QUANTITY:**

PRE DEVELOPMENT: AREA=0.92 AC; C=0.9; Tc=5 MIN.; I10=7.2 IN/HR $Q_{10}=(0.9)*(7.2)*(0.92) = 5.96 \text{ CFS}$

POST DEVELOPMENT: AREA=0.92 AC; C=0.9; Tc=5.95 MIN.; I10=7.0 IN/HR

 $Q_{10}=(0.9)*(7.0)*(0.945) = 5.96 \text{ CFS}$

STORMWATER QUALITY:

THERE IS NO CHANGE TO THE IMPERVIOUSNESS OF THE SITE. PRE DEVELOPED IMPERVIOUSNESS = 100% POST DEVELOPED IMPERVIOUSNESS = 100%

REFER TO DRAWING C3.1 FOR STORM SEWER DESIGN COMPUTATIONS.

CONSTRUCTION SEQUENCE

- 1. THE OWNER SHALL GIVE THE INSPECTOR 48 HOURS NOTIFICATION TO SCHEDULE AN ON-SITE PRE-CONSTRUCTION MEETING FOR THE ISSUANCE OF A LAND DISTURBANCE PERMIT. THE CERTIFIED RESPONSIBLE LAND DISTURBER (CRLD) MUST ATTEND THE PRE-CONSTRUCTION MEETING.
- 2. ALL VEGETATIVE AND STRUCTURAL EROSION AND SEDIMENT CONTROL PRACTICES WILL BE CONSTRUCTED AND MAINTAINED ACCORDING TO THE MINIMUM STANDARDS AND SPECIFICATIONS OF THE VIRGINIA EROSION & SEDIMENT CONTROL HANDBOOK, AND VIRGINIA REGULATION VR 625-02-00.
- 3. PERMANENT OR TEMPORARY SOIL STABILIZATION SHALL BE APPLIED TO DENUDED AREAS WITHIN SEVEN DAYS AFTER FINAL GRADE IS REACHED ON ANY PORTION OF THE SITE. TEMPORARY SOIL STABILIZATION SHAL BE APPLIED WITHIN SEVEN DAYS TO DENUDED AREAS THAT MAY NOT BE AT FINAL GRADE BUT WILL REMAIN DORMANT FOR LONGER THAN 30 DAYS. PERMANENT STABILIZATION SHALL BE APPLIED TO AREAS THAT ARE TO BE LEFT DORMANT FOR MORE THAN ONE YEAR.
- 4. CONTRACTOR SHALL TAKE PRECAUTIONARY MEASURES TO PROTECT EXISTING SITE FEATURES TO REMAIN AT ALL TIMES DURING CONSTRUCTION. ANY DAMAGE TO EXISTING SITE FEATURES TO REMAIN SHALL BE REPAIRED IMMEDIATELY BY THE CONTRACTOR AT NO ADDITIONAL CHARGE TO THE OWNER.
- 5. BEGIN SITE DEMOLITION INCLUDING PAVEMENT REMOVAL.
- 6. BEGIN SITE GRADING OPERATIONS.
- 7. BRING THE SITE TO SUB-GRADE ELEVATIONS AND BEGIN BUILDING SLAB AND FOUNDATION CONSTRUCTION.
- 8. COMPLETE CONSTRUCTION INCLUDING STORM SEWER CONSTRUCTION, PAVING AND FINAL GRADING.
- 9. MAINTAIN EXISTING SITE GRAVEL FOR PURPOSES OF CONSTRUCTION ENTRANCES. DO NOT TRANSPORT SEDIMENT OFF OF THE SITE. CONSTRUCTION ENTRANCES SHALL BE MAINTAINED UNTIL THERE IS NO

LONGER A THREAT TO TRANSPORT SOIL FROM THE CONSTRUCTION SITE.

SOIL DATA PROJECT AREA: 41 - URBAN LAND

EROSION AND SEDIMENT CONTROL NOTES

- 1. PERMANENT OR TEMPORARY SOIL STABILIZATION SHALL BE APPLIED TO ALL DENUDED AREAS WITHIN SEVEN DAYS AFTER FINAL GRADE IS REACHED ON ANY PORTION OF THE SITE. TEMPORARY SOIL STABILIZATION SHALL BE APPLIED WITHIN SEVEN DAYS TO DENUDED AREAS THAT MAY NOT BE AT FINAL GRADE BUT WILL REMAIN DORMANT (UNDISTURBED) FOR LONGER THAN 30 DAYS. PERMANENT STABILIZATION SHALL BE APPLIED TO AREAS
- THAT ARE TO BE LEFT DORMANT FOR MORE THAN ONE YEAR. DURING CONSTRUCTION OF THE PROJECT, SOIL STOCKPILES SHALL BE STABILIZED OR PROTECTED WITH SEDIMENT TRAPPING MEASURES. THE APPLICANT IS RESPONSIBLE FOR THE TEMPORARY PROTECTION AND PERMANENT STABILIZATION OF ALL SOIL STOCKPILES ON SITE AS WELL AS SOIL INTENTIONALLY TRANSPORTED FROM THE PROJECT.
- A PERMANENT VEGETATIVE COVER SHALL BE ESTABLISHED ON DENUDED AREAS NOT OTHERWISE PERMANENTLY STABILIZED. PERMANENT VEGETATION SHALL NOT BE CONSIDERED ESTABLISHED UNTIL A GROUND COVER IS ACHIEVED THAT, IN THE OPINION OF THE LOCAL PROGRAM ADMINISTRATOR OR HIS DESIGNATED AGENT, IS UNIFORM, MATURE ENOUGH TO SURVIVE AND WILL INHIBIT EROSION.
- SEDIMENT BASINS AND TRAPS, PERIMETER DIKES, SEDIMENT BARRIERS AND OTHER MEASURES INTERNED TO TRAP SEDIMENT SHALL BE CONSTRUCTED AS A FIRST STEP IN ANY LAND-DISTURBING ACTIVITY AND SHALL BE MADE FUNCTIONAL BEFORE UP SLOPE LAND DISTURBANCE TAKES PLACE.
- STABILIZATION MEASURES SHALL BE APPLIED TO EARTHEN STRUCTURES SUCH AS DAMS, DIKES AND DIVERSIONS IMMEDIATELY AFTER INSTALLATION.
- 6. CONCENTRATED RUNOFF SHALL NOT FLOW DOWN CUT OR FILL SLOPES UNLESS CONTAINED WITHIN AN ADEQUATE TEMPORARY OR PERMANENT CHANNEL, FLUME OR SLOPE DRAIN STRUCTURE.
- 7. WHENEVER WATER SEEPS FROM A SLOPE FACE, ADEQUATE DRAINAGE OR OTHER PROTECTION SHALL BE PROVIDED.
- WHERE CONSTRUCTION VEHICLE ACCESS ROUTES INTERSECT PAVED PUBLIC ROADS, PROVISIONS SHALL BE MADE TO MINIMIZE THE TRANSPORT OF SEDIMENT BY VEHICULAR TRACKING ONTO THE PAVED SURFACE. WHERE SEDIMENT IS TRANSPORTED ONTO A PUBLIC ROAD SURFACE. THE ROAD SHALL BE CLEANED THOROUGHLY AT THE END OF EACH DAY. SEDIMENT SHALL BE REMOVED FROM THE ROADS BY SHOVELING OR SWEEPING AND TRANSPORTED TO A SEDIMENT CONTROL DISPOSAL AREA. STREET WASHING SHALL BE ALLOWED ONLY AFTER SEDIMENT IS REMOVED IN THIS MANNER. THIS PROVISION SHALL APPLY TO INDIVIDUAL SUBDIVISION LOTS AS WELL AS TO LARGER LAND DISTURBING ACTIVITIES.
- 9. ALL TEMPORARY EROSION AND SEDIMENT CONTROL MEASURES SHALL BE REMOVED WITHIN 30 DAYS AFTER FINAL SITE STABILIZATION OR AFTER THE TEMPORARY MEASURES ARE NO LONGER NEEDED UNLESS OTHERWISE AUTHORIZED BY THE LOCAL PROGRAM ADMINISTRATOR. TRAPPED SEDIMENT AND THE DISTURBED SOIL AREAS RESULTING FROM THE DISPOSITION OF TEMPORARY MEASURES SHALL BE PERMANENTLY STABILIZED TO PREVENT FURTHER EROSION AND SEDIMENTATION.
- 10. NO MATERIALS ARE TO BE STORED OUTSIDE THE LIMITS OF CONSTRUCTION.

EROSION AND SEDIMENT CONTROL MAINTENANCE


- ALL EROSION AND SEDIMENT CONTROL MEASURES SHALL BE CHECKED DAILY AND AFTER EACH RUNOFF PRODUCING RAINFALL EVENT. ANY NECESSARY REPOIRS OR REPLACEMENTS SHALL BE MADE BY THE CONTRACTOR IMMEDIEATELY. THE OLLOWING ITEMS SHALL BE CHECKED IN
- A. RESTORE CONSTRUCTION ENTRANCES TO WORKING ORDER IF RUTTED OUT OR IF A LARGE AMOUNT OF SEDIMENT HAS ACCUMULATED IN THE GRAVEL. DO NOT ALLOW WASHRACK TO ACCUMULATE SEDIMENT; RINSE A MINIMUM OF ONCE DAILY TO PREVENT BUILD UP. CHECK THE GRAVEL INLET PROTECTION FOR SEDIMENT BUILD UP

PREVENTING DRAINAGE. IF THE GRAVEL IS CLOGGED BY SEDIEMTN,

EROSION AND SEDIMENT CONTROL LEGEND


REMOVE AND CLEAN OR REPLACE.

SYMBOL

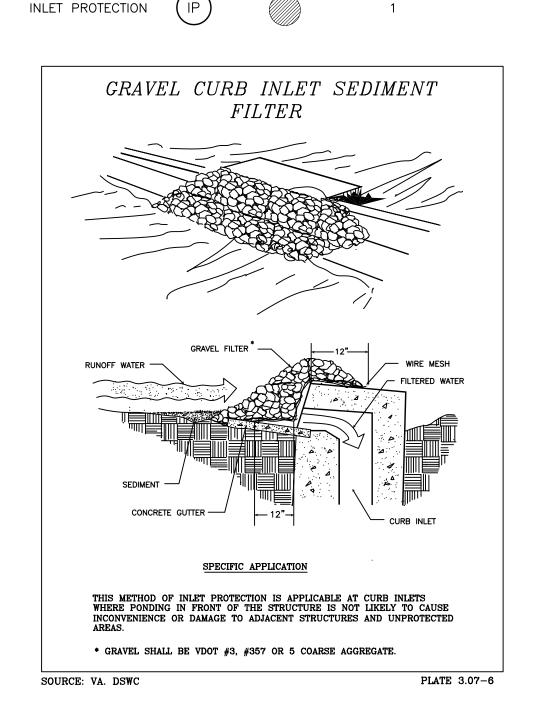

K Factor, Whole Soll–City of Richmond, Virginia (Landmark Theater-Kfactor)



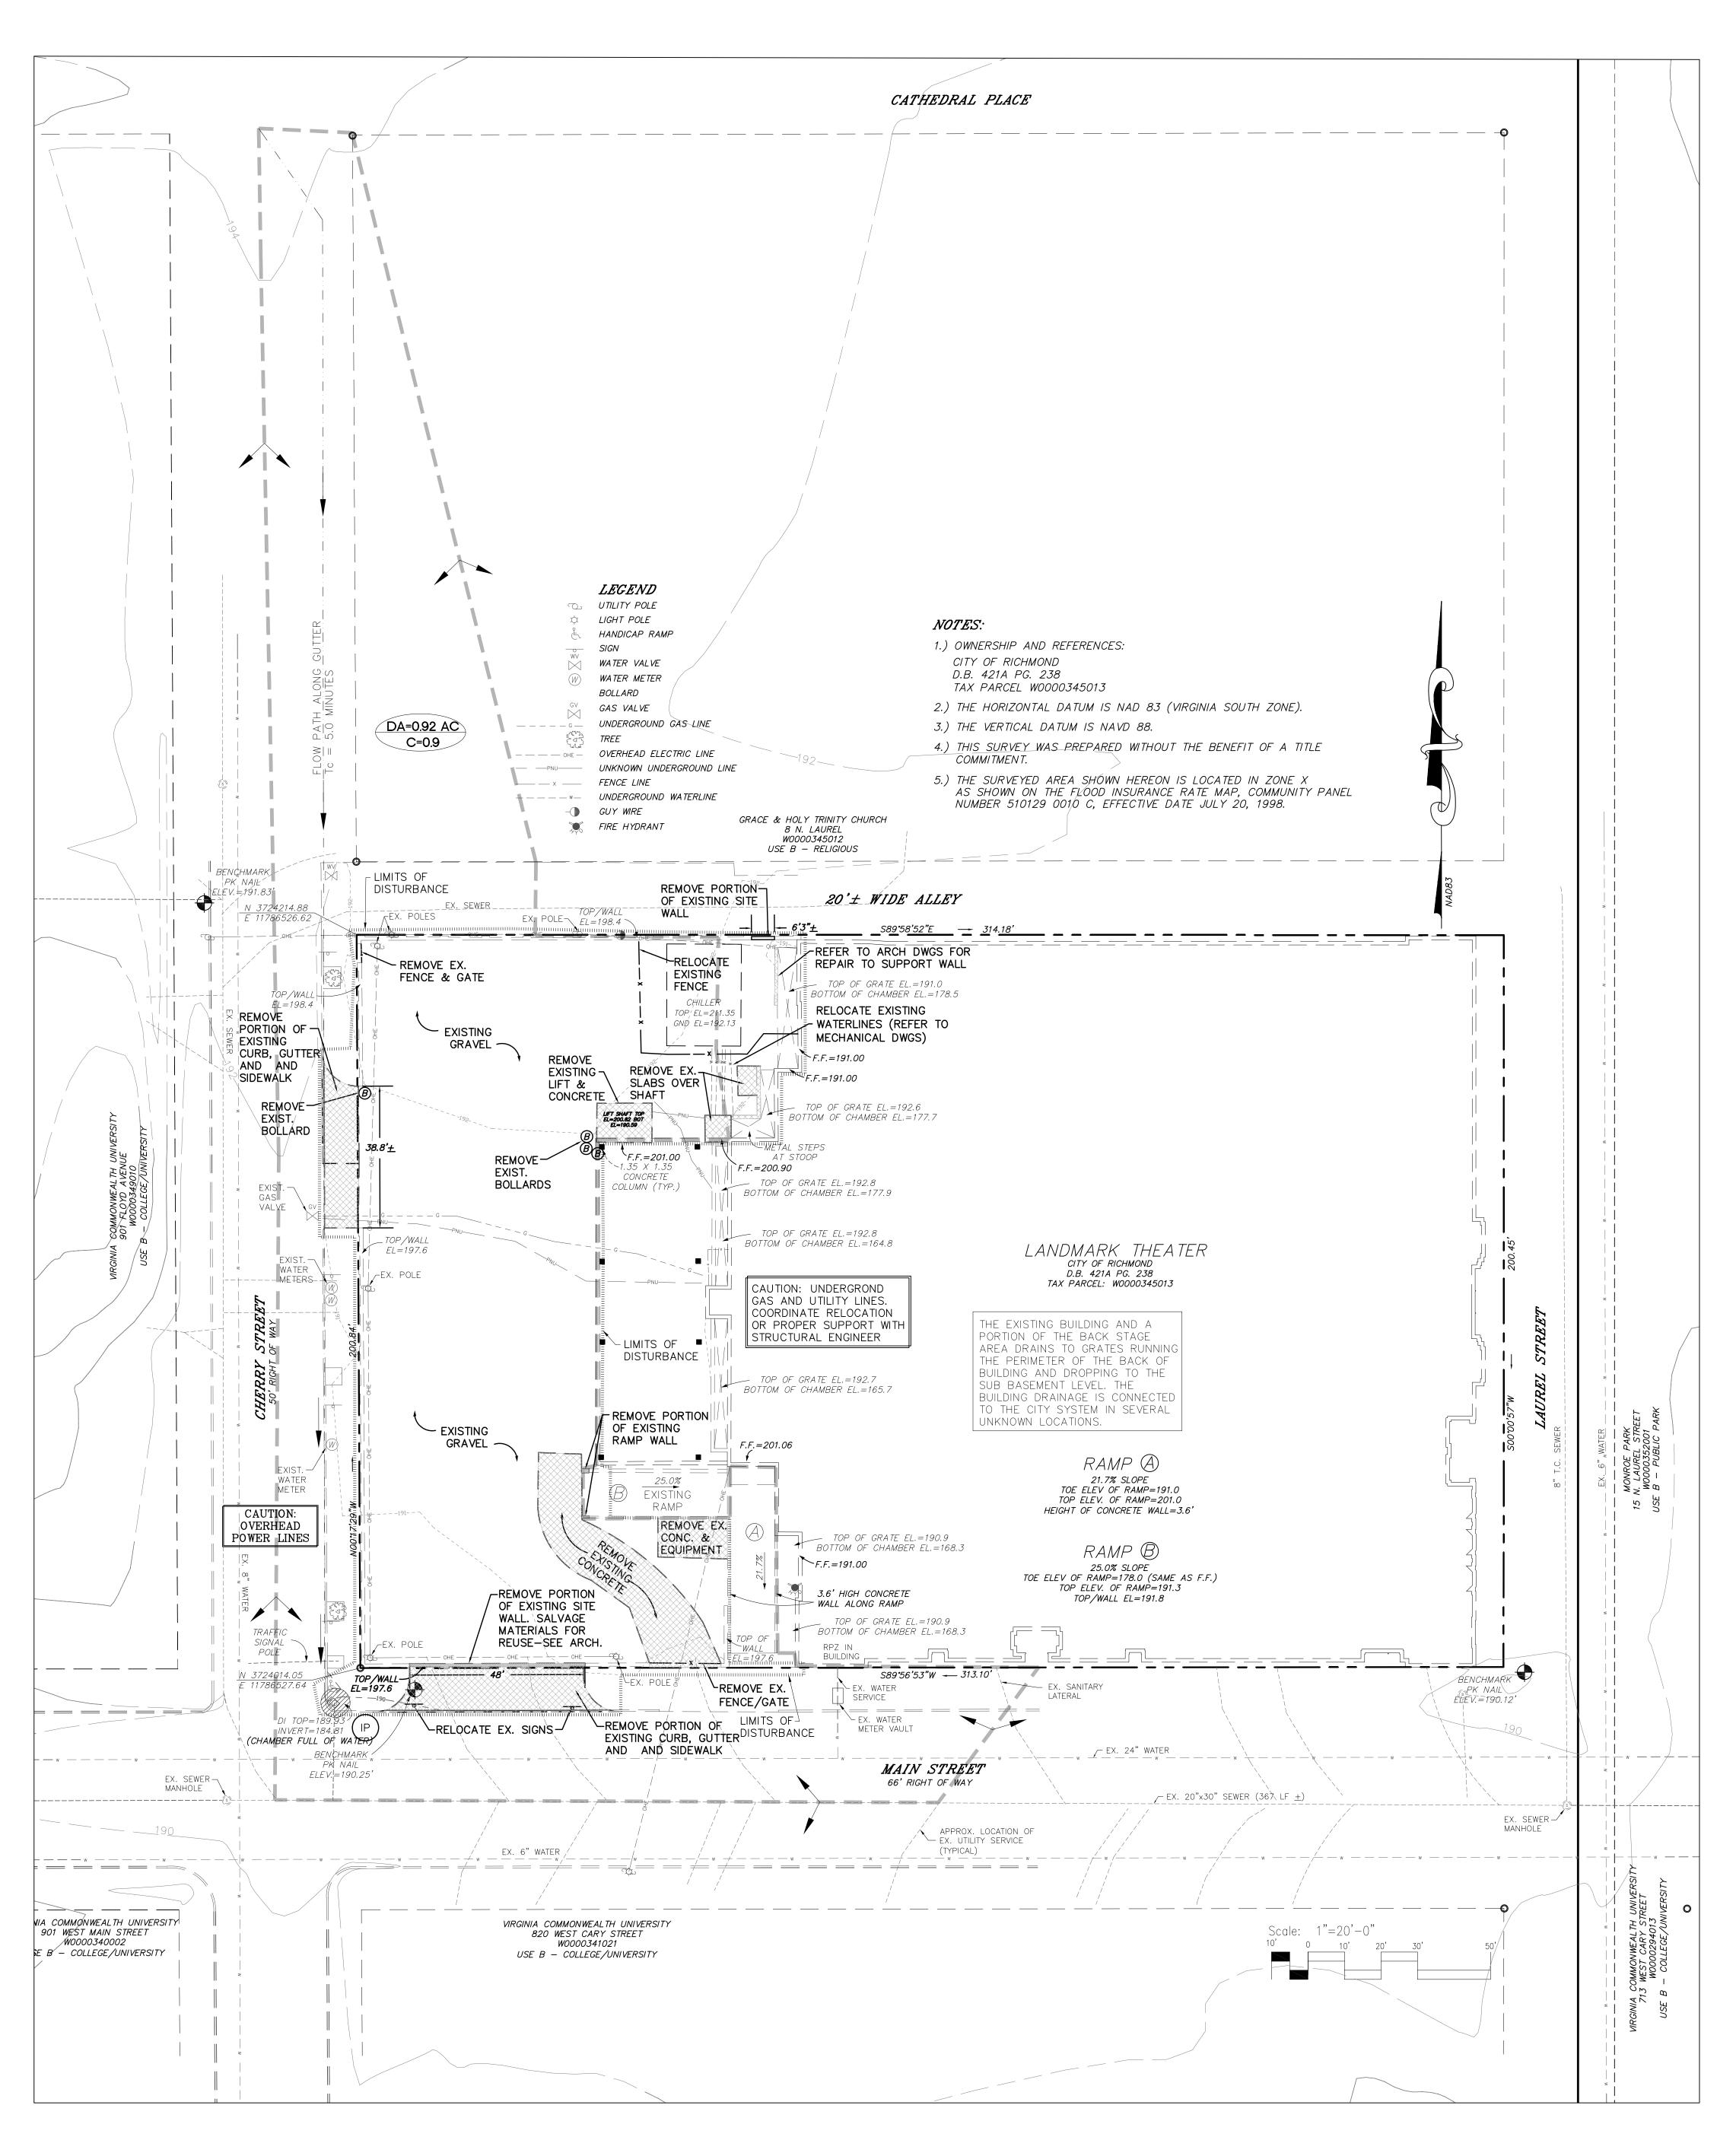

COORDINATE ALL DEMOLITION OF SITE ELEMENTS WITH ARCHITECTURAL DEMOLITION PLAN D1.



1627 Westbrook Avenue Richmond, VA 23227 804.399.0500

CITY OF RICHMOND LANDMARK THEATRE **RENOVATIONS - PHASE I**

0806


05-19-08

09-19-08

10-23-08

DATE:

PROJECT NO: FINAL OWNER REVIEW **BUILDING PERMIT** PERMIT REVISIONS 10-27-08

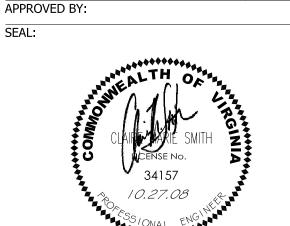


EXISTING CONDITIONS & SITE DEMOLITION PLAN

DRAWING NO.:


GENERAL CONSTRUCTION NOTES

- 1. ALL UNDERGROUND UTILITIES ILLUSTRATED ARE APPROXIMATE AS LOCATED BY ACCUMARK AND PAINTED LINES WERE FIELD LOCATED BY JENNINGSTEPHENSON, PC. 2. CONTRACTOR SHALL CONTACT "MISS UTILITY" 48 HOURS PRIOR TO THE START OF ANY WORK. VERIFY LOCATION AND ELEVATION OF ALL UNDERGROUND UTILITIES IN THE AREA OF CONSTRUCTION PRIOR TO STARTING WORK. CONTACT THE ARCHITECT IMMEDIATELY IF LOCATION OR ELEVATION IS DIFFERENT FROM THAT INDICATED IF THERE APPEARS TO BE A CONFLICT, AND/OR UPON DISCOVERY OF ANY UTILITY NOT INDICATED. TO LOCATE UTILITIES, CALL "MISS UTILITY" OF CENTRAL VIRGINIA 1-800-552-7001.
- 3. ACQUIRE ANY AND ALL NECESSARY CONSTRUCTION PERMITS REQUIRED TO COMPLETE THE SITEWORK AND FURNISH COPIES
- 4. ALL WORK SHALL BE SUBJECT TO INSPECTION BY DESIGNATED OFFICIALS. NOTIFY THE CHIEF INSPECTOR 48 HOURS PRIOR TO
- START OF WORK. 5. PROTECT ALL EXISTING SITE FEATURES AT ALL TIMES DURING CONSTRUCTION. DAMAGE TO ANY ITEM NOT LISTED FOR REMOVAL OR RELOCATION ON THE DEMOLITION PLAN SHALL BE REPAIRED BY THE CONTRACTOR AT NO ADDITIONAL CHARGE TO THE OWNER. IF THERE ARE EXISTING SITE FEATURES IN CONFLICT WITH THE PROPOSED WORK NOT IDENTIFIED TO BE RELOCATED OR REMOVED, NOTIFY THE ARCHITECT IMMEDIATELY FOR CLARIFICATION.

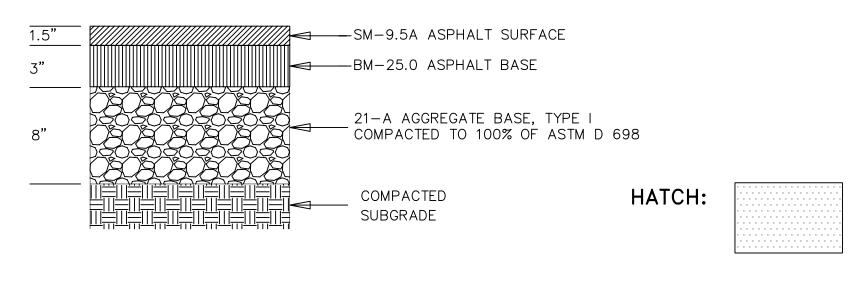


ASPHALT PAVEMENT SECTION

NOTE: PAVEMENT SECTIONS ARE BASED ON AN ASSUMED CBR OF 10. IF FIELD CONDITIONS VARY, NOTIFY ENGINEER FOR REVISED PAVEMENT SECTION.

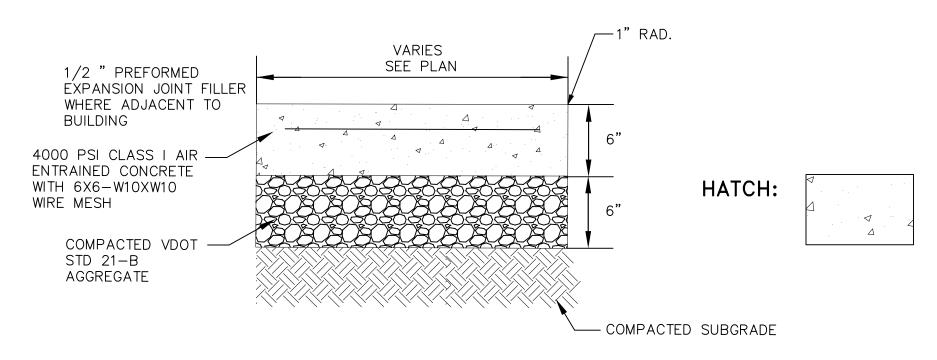

CONCRETE PAVEMENT SECTION TRASH COMPACTOR & DRIVEWAY ENTRANCES


NOTE: FINISH - TROWELED EDGES, BROOM FINISH SCORING EVERY 6'; EXPANSION JOINTS EVERY 30' MIN.

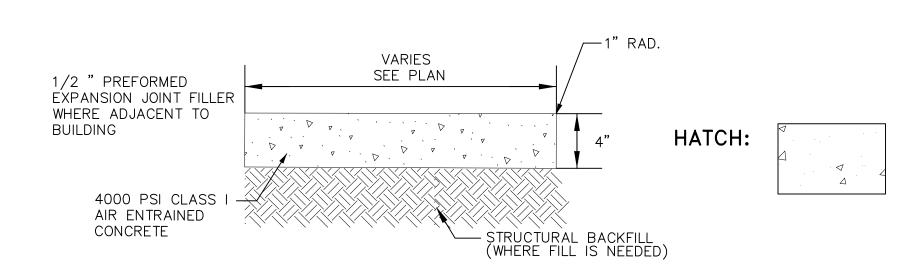


SIDEWALK DETAIL


NO SCALE

NOTE: FINISH - TROWELED EDGES, BROOM FINISH SCORING EVERY 6' EXPANSION JOINTS EVERY 30' MIN.

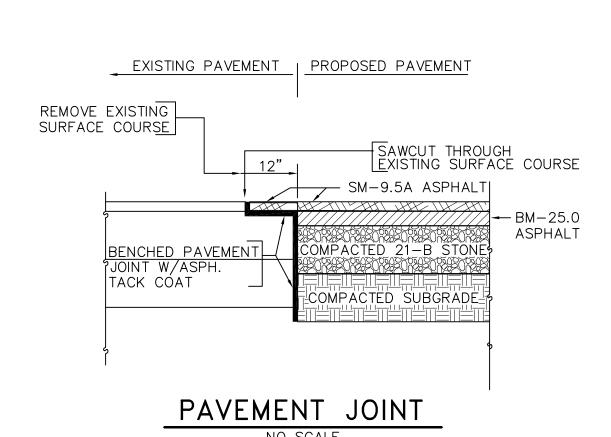


NOTE: PROPOSED PAVEMENT MUST TIE IN WITH EXISTING PAVEMENT

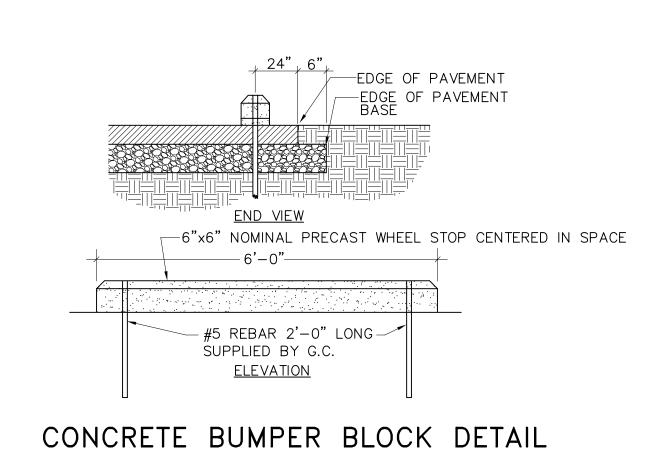

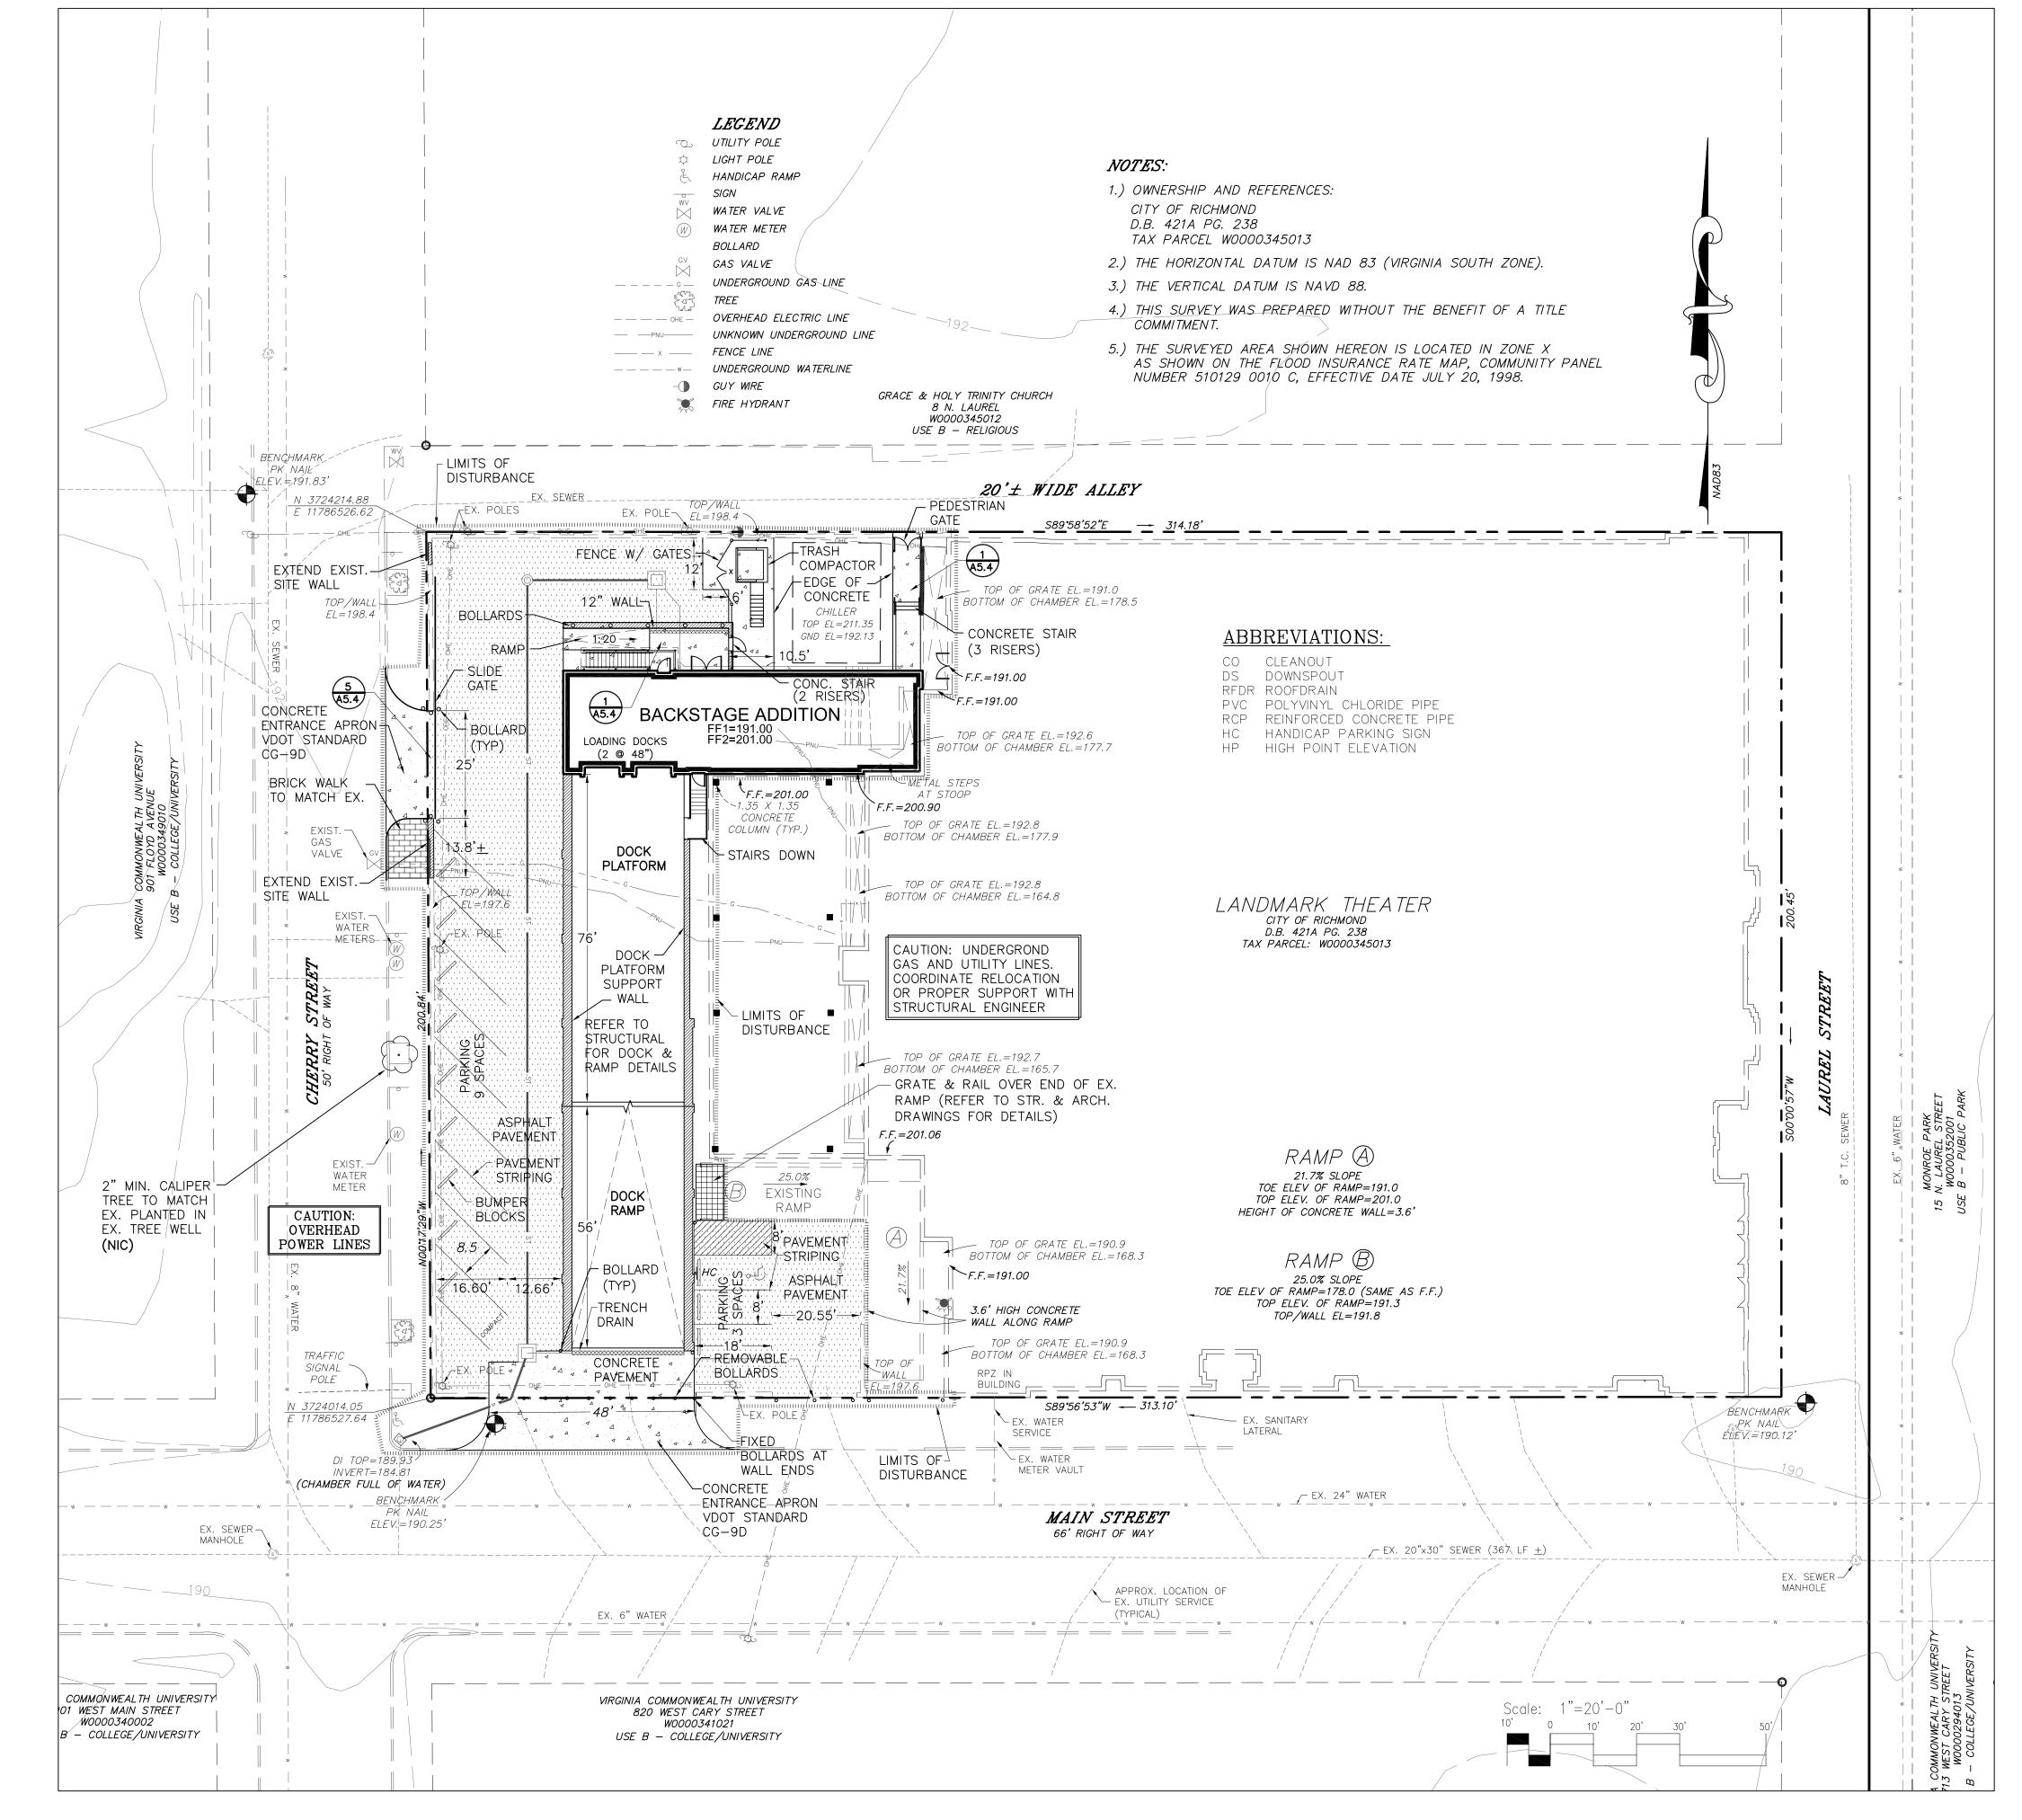

STORM SEWER DESIGN COMPUTATIONS

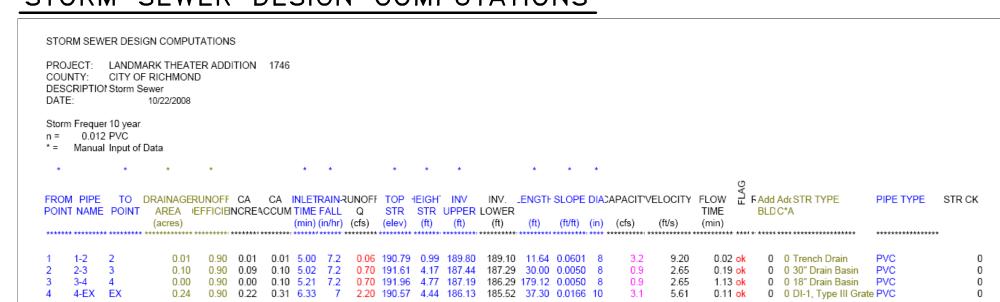

HYDRAULIC GRADE LINE COMPUTATIONS

													Hydrauli	c Grade Lin	e Analysis	,												
			Mannings	N Value:		0.012		Job#:	1746					Project:	LANDM	ARK TH	EATRE	RENO	ATIONS	- PH. 1		Date:	*****					
Initial	Inlet	Inlet		Outlet										,	Junction	Loss						Final	Inlet	Rim	Fig.	Fig.	Shap	Comments
Water	Sta.	Q	Invert	ı	Do	Q٥	Lo	Sfo	Hf	Vo	Но	Qi	Vi	QiVi	Vi sq.	Hi	Ang.	Н	Ht	1.30	0.50	Н		Elev.	Fig. Hi	H	Inlet	
Surface Elevation		<u> </u>	Elev.	Surf. Elev.				%							2g			delta		Ht	Ht		Surf. Elev.		Y/N	delta Y/N		10 year Storm
																					+	1			1			
																									1			
189.40	4	1.51	185.52	189.40	10"	2.20	37.3	0.86%	0.32	4.03	0.06	0.70	2.02	1.4	0.06	0.02	9	0.01	0.09	0.12	0.06	0.38	189.78	190.57	v	v	Y	OK -0.79 Ft.
189.78	3		186.29	189.78			179.1		0.52	2.02		0.70		1.4		0.02	_				0.04		190.34			v	Y	OK -1.63 Ft.
190.34	2	0.65	187.29	190.34	8"	0.70	30.0	0.29%	0.09	2.02	0.02	0.06	0.16	0.0	0.00	0.00	86	0.00	0.02	0.02	0.01	0.10	190.44	191.61	y	y	Y	OK -1.17 Ft.
190.44	1	0.06	189.10	190.44	8"	0.06	11.6	0.00%	0.00	0.16	0.00								0.00	0.00		0.00	190.44	190.79	y	у	N	OK -0.35 Ft.

REFERENCE ARCHITECTURAL DRAWINGS FOR ADDITIONAL DETAILING OF SITE ELEMENTS



1627 Westbrook Avenue Richmond, VA 23227 804.399.0500

CITY OF RICHMOND LANDMARK THEATRE **RENOVATIONS - PHASE I**


PROJECT NO:	080
ISSUE:	DATI
FINAL OWNER REVIEW	05-19-08
BUILDING PERMIT	09-19-08
PERMIT REVISIONS	10-23-08
BID	10-27-08
APPROVED BY:	
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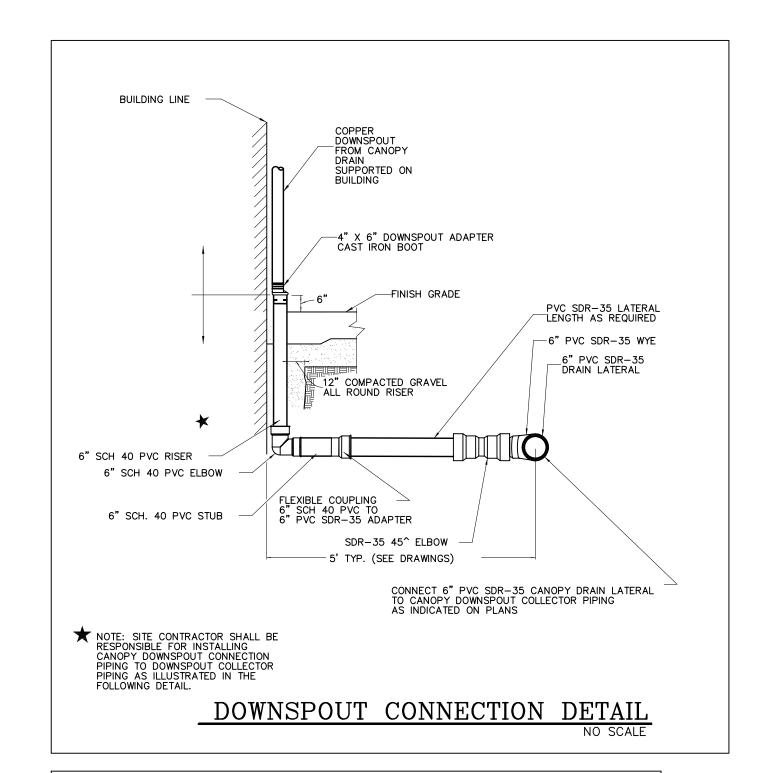



DRAWING TITLE:

LAYOUT & UTILITY PLAN

DRAWING NO.:



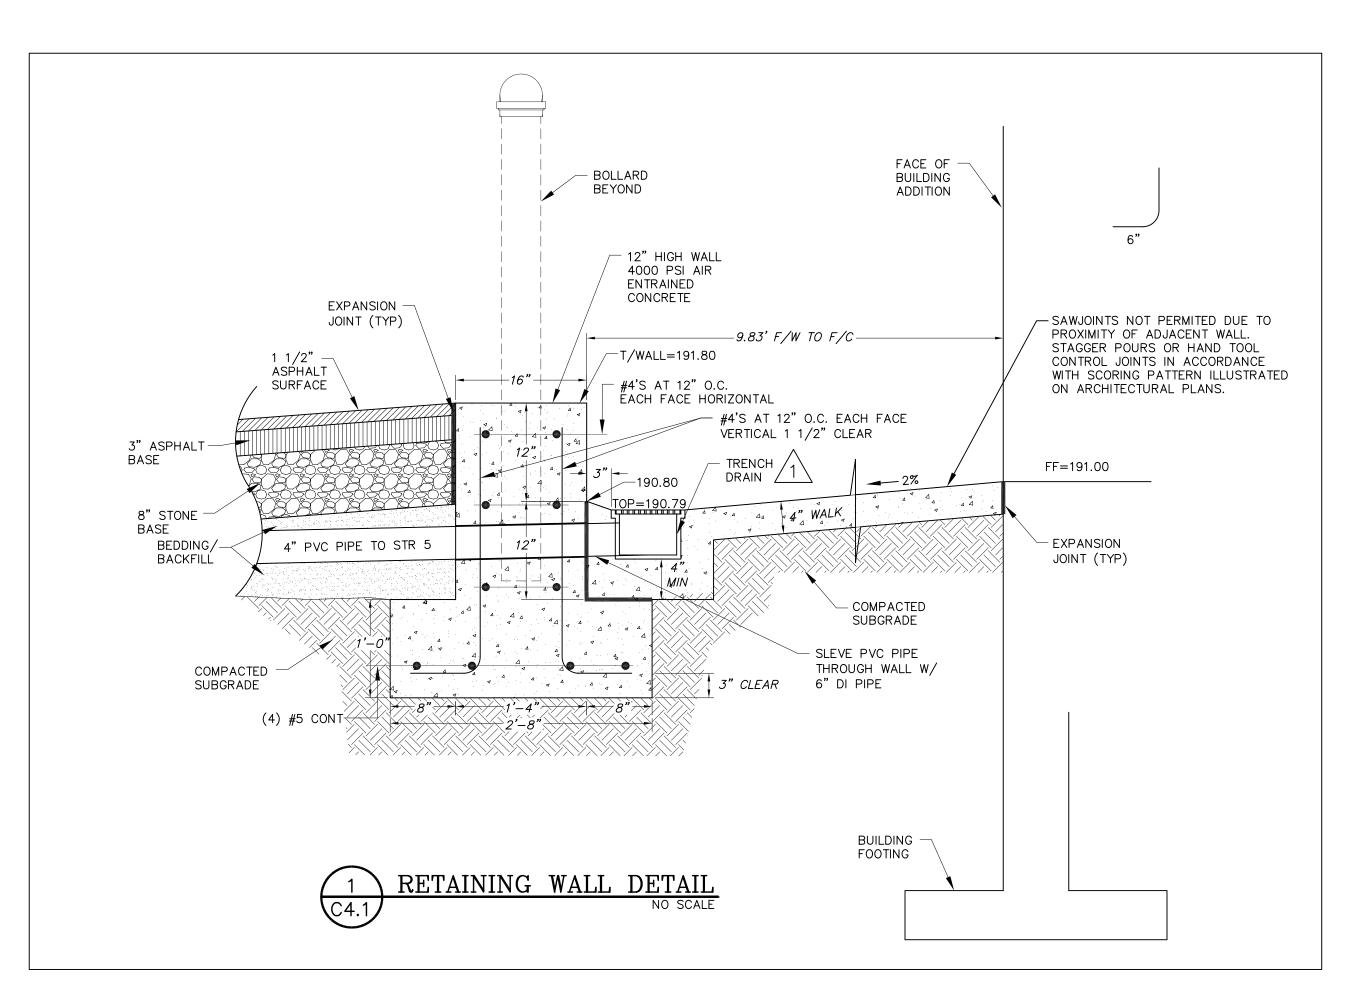

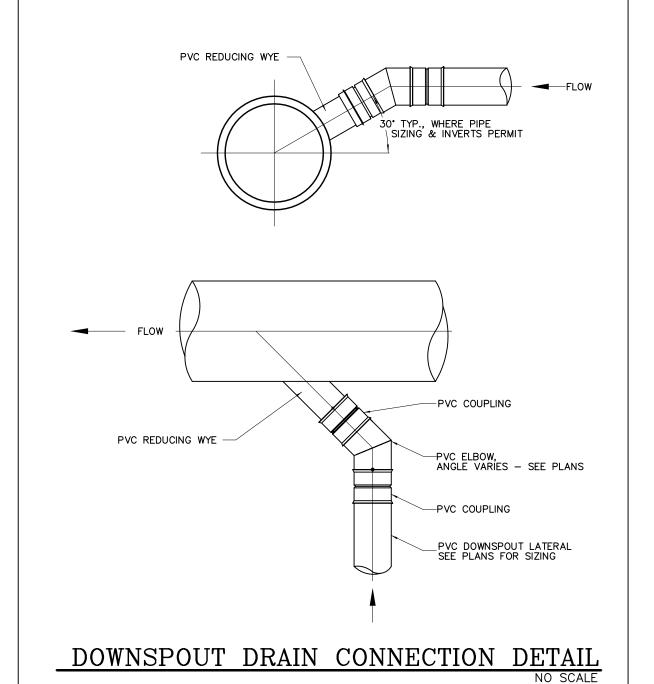



LIGHT DUTY CAST IRON TRENCH DRAIN BY
NEENAH FOUNDARY R-4995-A2
OR APPROVED EQUAL
TOP ELEVATION = 190.80
GRATE LENGTH = 18'
GRATE WIDTH = 7"
BASIN DEPTH = 4¾"
SIDE DISCHARGING WITH 4" PVC PIPE
SERVICEABLE/OPERABLE LID

30" PVC DRAIN BASIN W/TRAFFIC RATED

GRATE BY NYLOPLAST OR APPROVED EQUAL

TOP = 191.61

INV = 187.44

18" PVC DRAIN BASIN W/TRAFFIC RATED SOLID LID BY NYLOPLAST OR APPROVED EQUALTOP = 191.96
INV IN = 187.29
INV OUT = 187.19

CITY OF RICHMOND STANDARD DROP INLET

W/ GAS TRAP

TOP = 190.57


INV IN = 186.19


INV OUT = 186.13

8" PVC 45° BEND


HEAVY DUTY CAST IRON TRENCH DRAIN
NEENAH FOUNDARY R-4996-M OR
APPROVED EQUAL
TOP ELEVATION = 190.90
GRATE LENGTH = 25'
GRATE WIDTH = 11½"
BASIN DEPTH = 6"
END DISCHARGING WITH 4" PVC PIPE

SERVICEABLE/OPERABLE LID

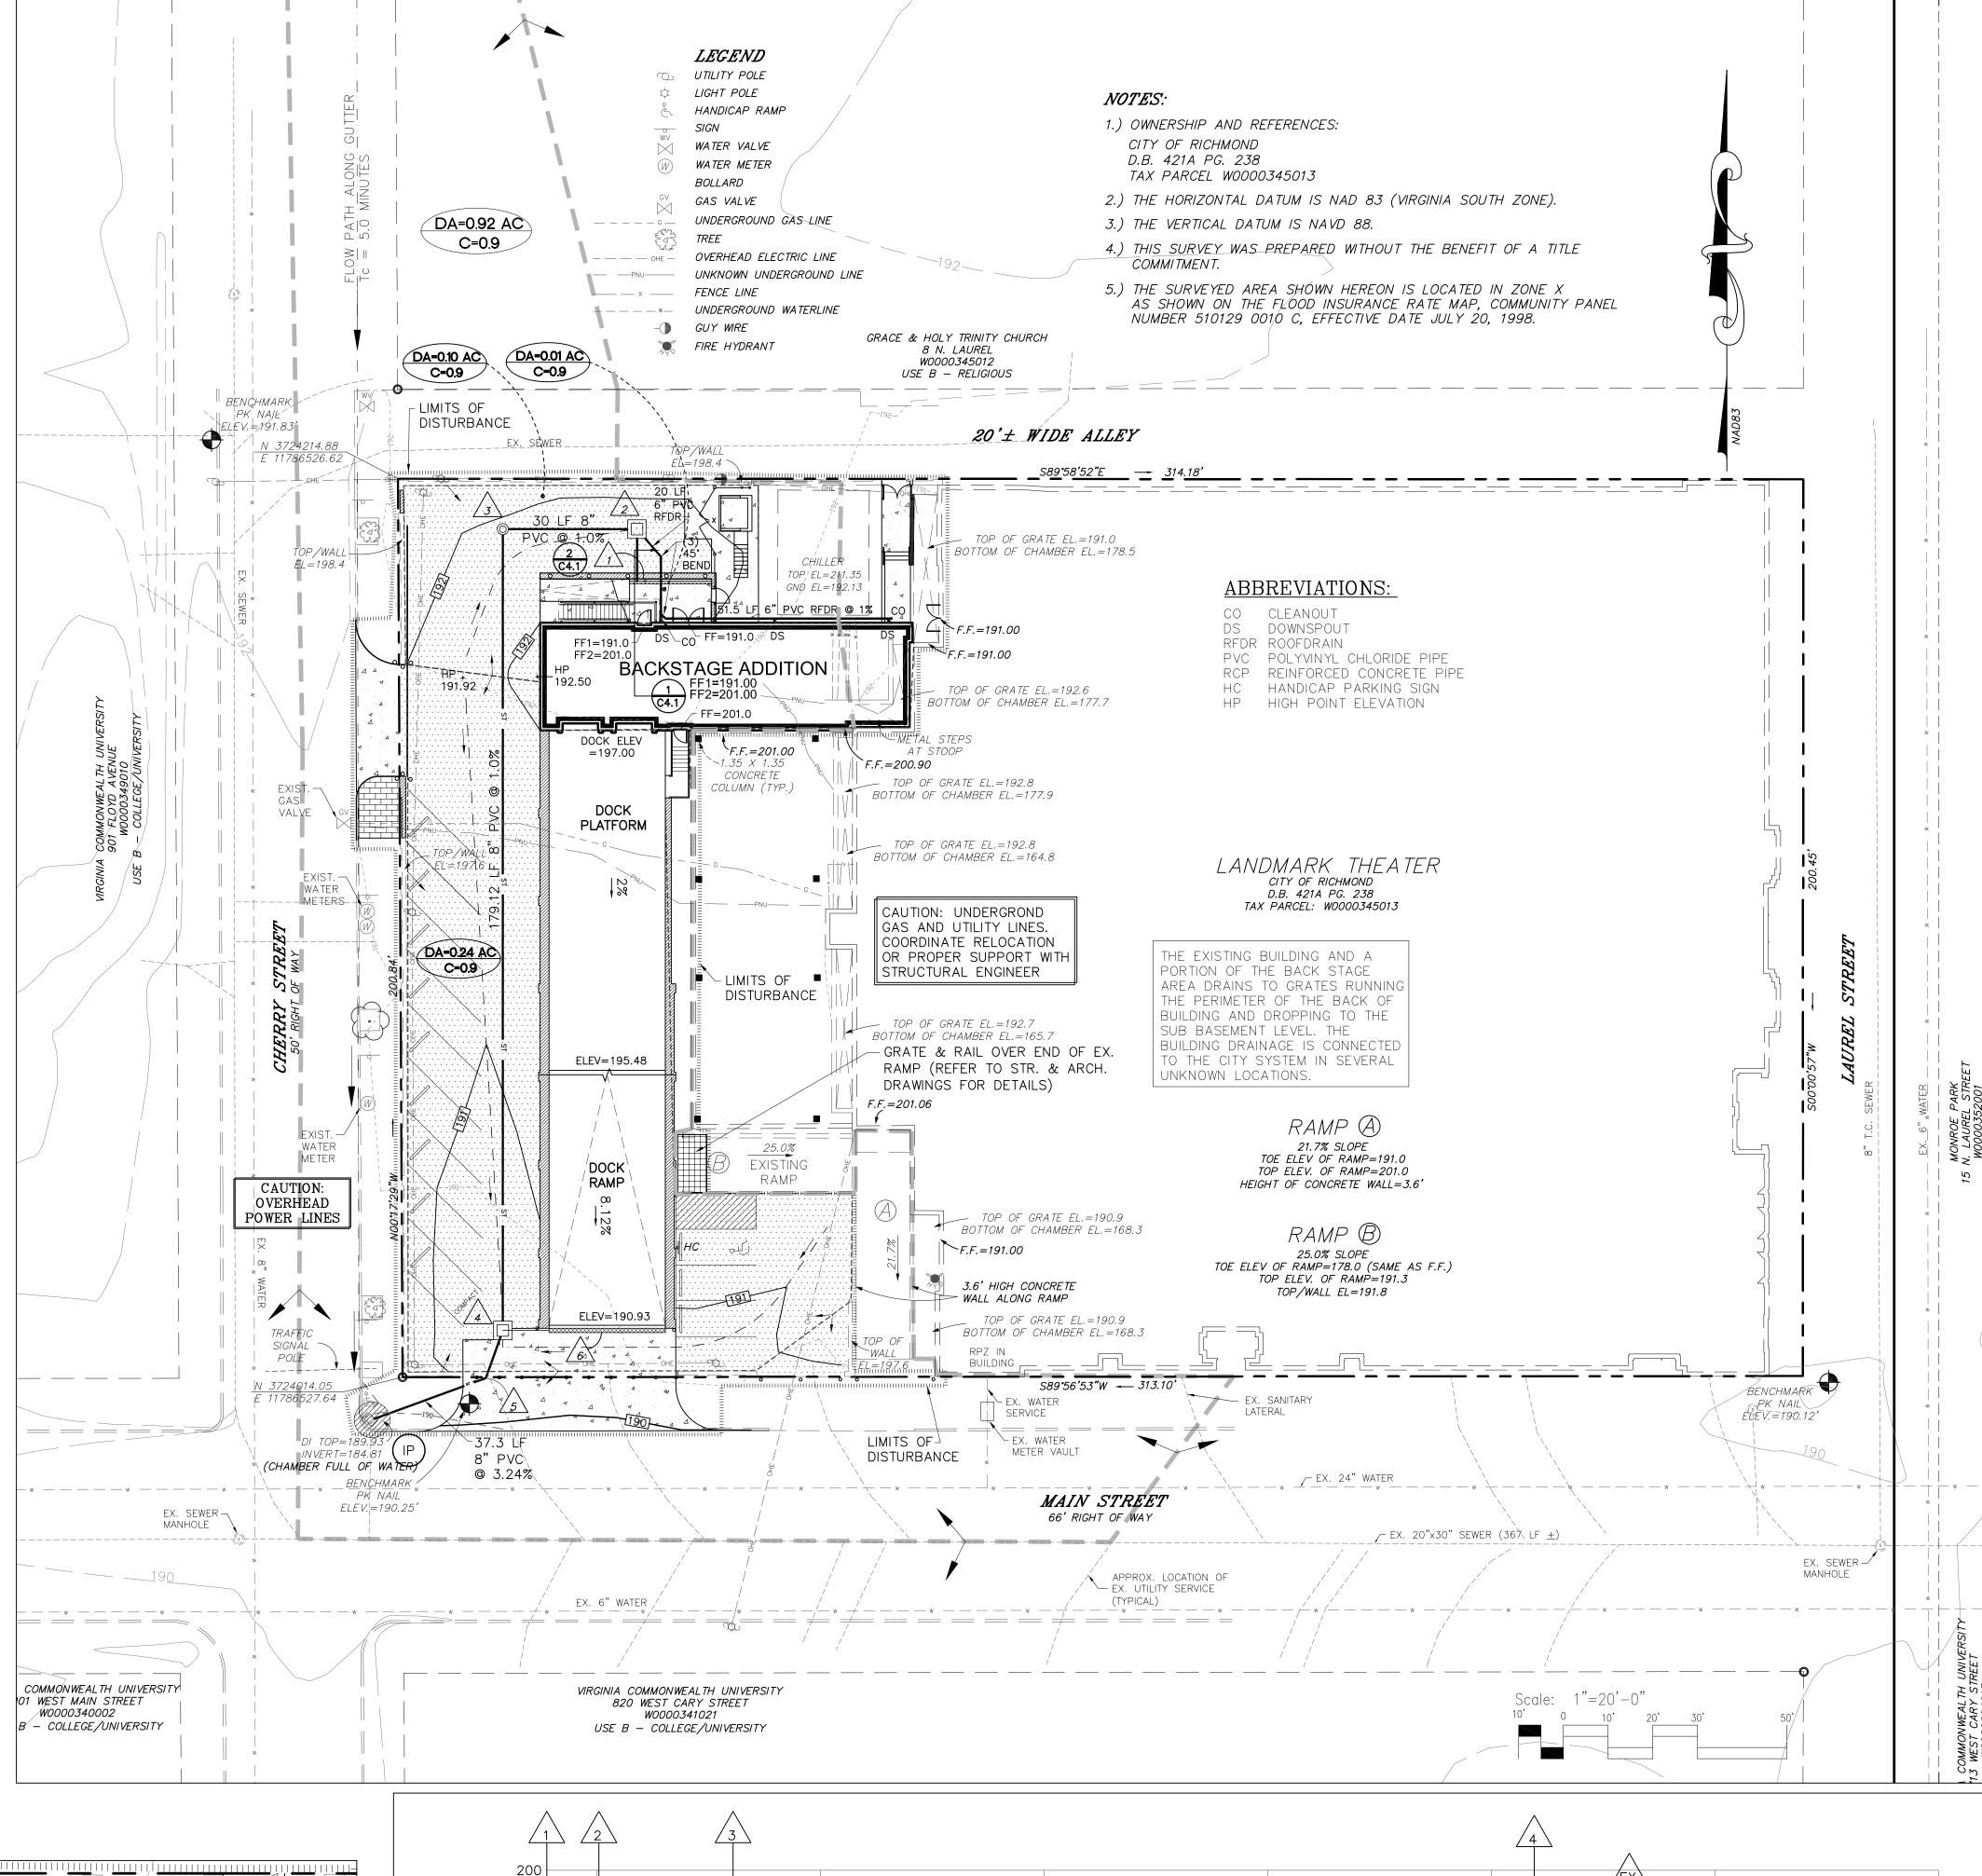

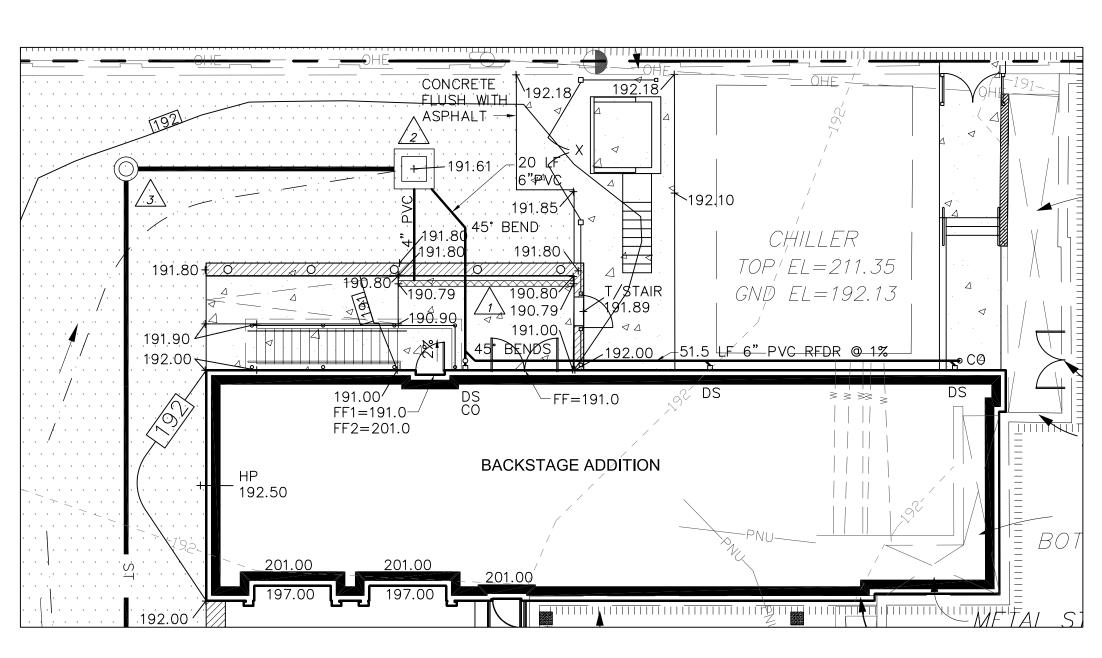

SERVICE AREA SPOT ELEVATION PLAN

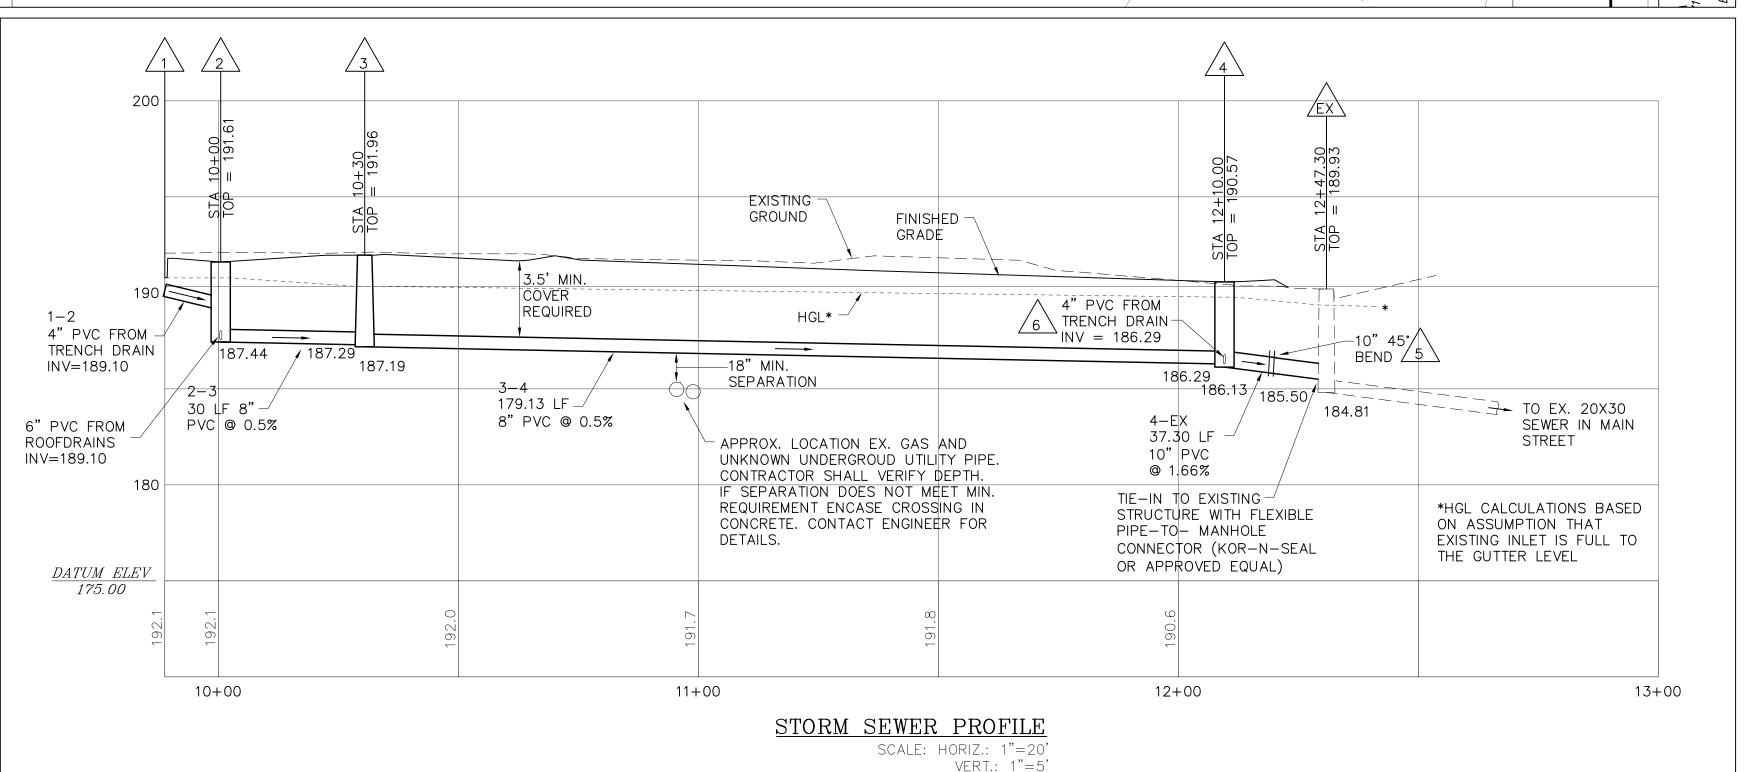

REFERENCE
ARCHITECTURAL
DRAWINGS FOR
ADDITIONAL DETAILING
OF SITE ELEMENTS



Richmond, VA 23227

804.399.0500

CITY OF RICHMOND
LANDMARK THEATRE
RENOVATIONS - PHASE I

 PROJECT NO:

 0806

 ISSUE:
 DATE:


 FINAL OWNER REVIEW
 05-19-08

 BUILDING PERMIT
 09-19-08

 PERMIT REVISIONS
 10-23-08

 BID
 10-27-08

 APPROVED BY:

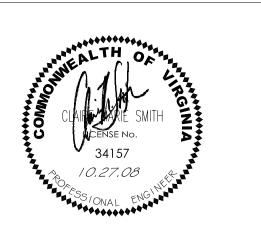

DRAWING TITLE:

GRADING &

DRAINAGE PLAN

DRAWING NO.:

C4.1